
CITY OF MEDINA

KING COUNTY WASHINGTON

2024 ADA IMPROVEMENTS & OVERLAY

TIB PROJECT NO. P-P-109(P05)-1 & NO. 2-P-109(007)-1

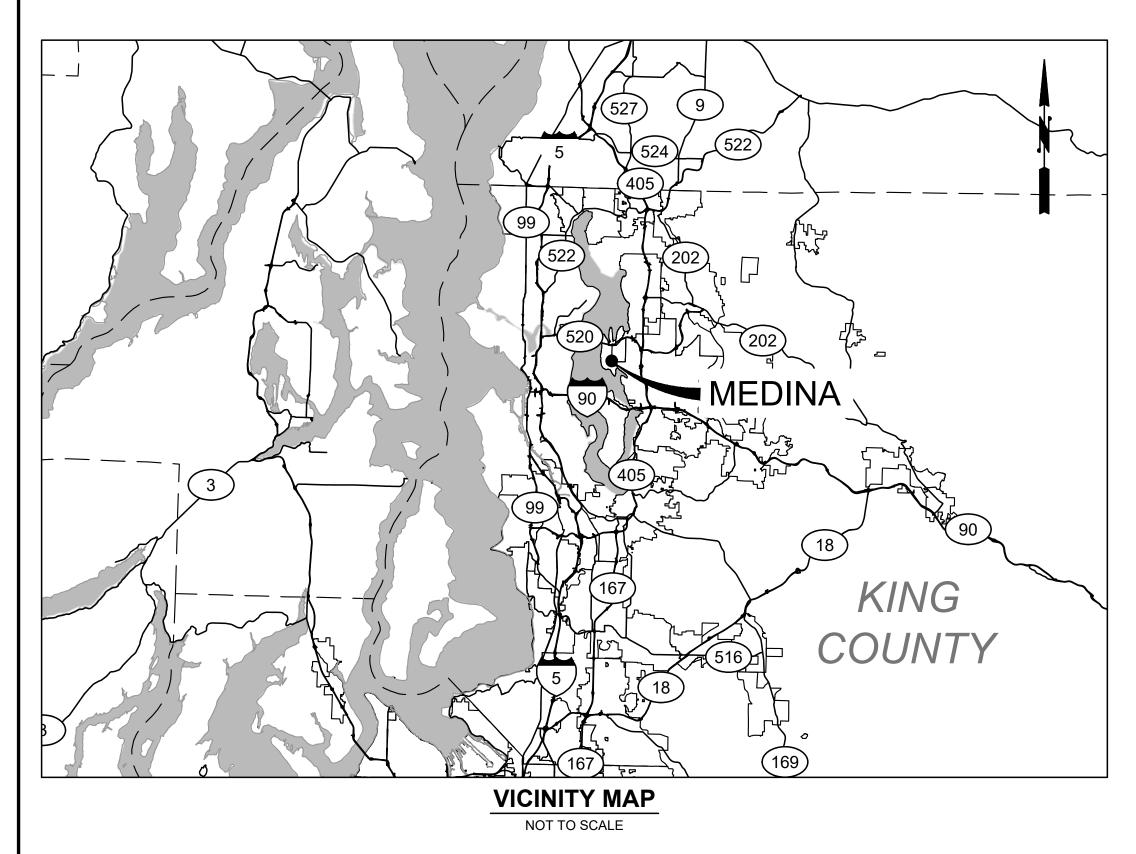




CITY OFFICIALS

JESSICA ROSSMAN

Mayor

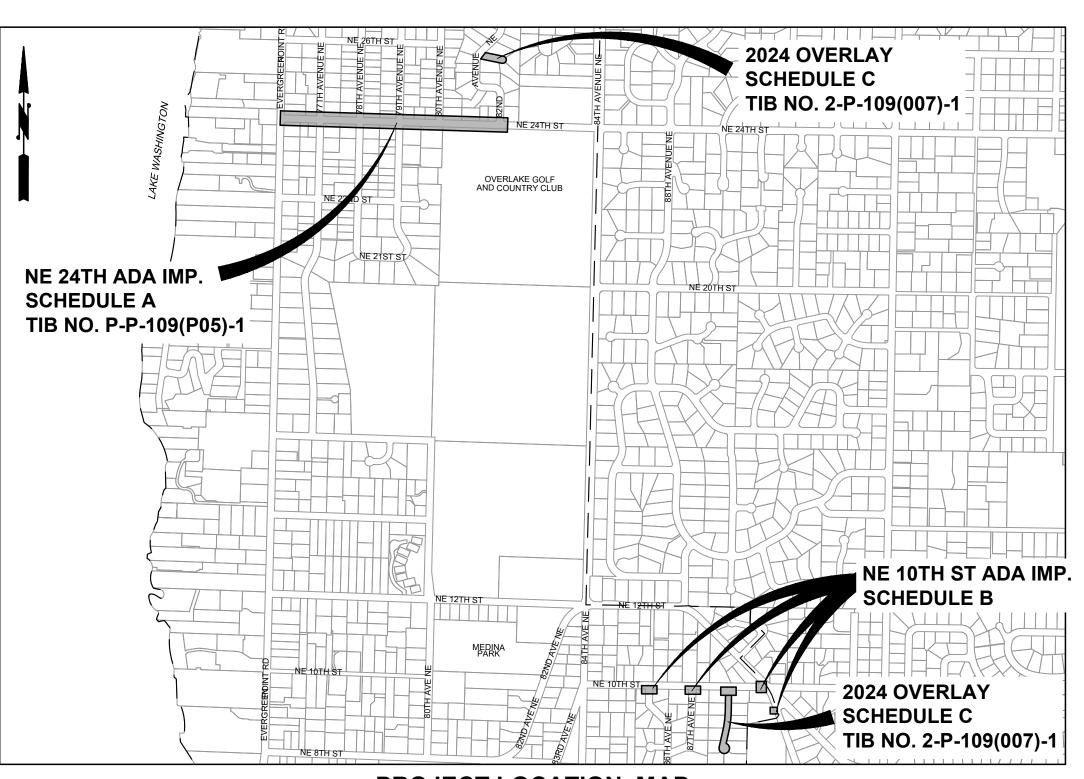

PROJECT LOCATION MAP

JENNIFER GARONE

MICHAEL LUIS

City Council

HARINI GOKUL

MAC JOHNSTON

JOSEPH BRAZEN

City Council

STEVE BURNS
CITY MANAGER

RANDY REEVES
DEPUTY MAYOR

RYAN OSADA
PUBLIC WORKS DIRECTOR



APRIL 2024 G&O #24432, #24435, #24436

SHT

SQ STA

STD

TB TC

TEL

TESC

THRD

THRU

TYP

VERT

W

W/

WSDOT

SPECS

SHEET SLOPE

SQUARE

STATION

STANDARD THRUST BLOCK

TOP OF CURB

TELEPHONE

THREADED THROUGH

TYPICAL

WITH

VERTICAL WEST

WITHOUT

TEMPORARY EROSION AND SEDIMENT CONTROL

WASHINGTON STATE DEPARTMENT OF TRANSPORTATION

SPECIFICATIONS

LINET	YPES	
<u>EXISTING</u>	PROPOSED	DESCRIPTION
SURFACE I	<u>FEATURES</u>	
		CURB (TYPE AS NOTED)
		CURB & GUTTER
		ASPHALT PAVEMENT
		GRAVEL SURFACING
A 4		CONCRETE SURFACING
		CEMENT CONC. SIDEWALK
		SUBGRADE REPAIR
x x	V//////	PAVEMENT PLANING FENCE/RAILING (TYPE AS NOTED)
. ~ .		SHRUB/TREE/VEGETATION LINE
		EDGE OF LANDSCAPING/RESTORATION
		RIGHT-OF-WAY LINE
	<u> </u>	CENTERLINE OF CONSTRUCTION
		PROPERTY LINE
		CONTOUR LINE
		SAWCUT LINE (APPROXIMATE LOCATION)
———— OH ————		OVERHEAD UTILITIES
——— E ———		BURIED ELECTRICAL
— Т —		BURIED TELEPHONE/COMMUNICATIONS
——————————————————————————————————————		BURIED COMMUNICATIONS
TV		BURIED CABLE TELEVISION
———— G ————		GAS MAIN (SIZE AS NOTED)
W		WATER MAIN (SIZE AS NOTED)
s		SANITARY SEWER MAIN (SIZE AS NOTED)
D		STORM DRAIN (SIZE AS NOTED)
>		CULVERT (SIZE & TYPE AS NOTED)
		DITCH CENTERLINE/THALWEG

SIGNALIZATION/ILLUMINATION SYMBOLS

EXISTING	PROPOSED	DESCRIPTION
		JUNCTION BOX (TYPE I, II, VIII)
$\qquad \qquad $		LIGHT/LUMINAIRE POLE W/ARM
×		POLE MOUNTED LIGHT

WATER SYMBOLS CHANNELIZATION SYMBOLS

EXISTING	PROPOSED	DESCRIPTION
0		GUARD POST / BOLLARD
⊞		WATER METER
VV		WATER VAULT (SIZE VARIES
- <u></u>		FIRE HYDRANT (3-NOZZLE)
\bowtie		GATE VALVE

GAS/POWER/TELEPHONE SYMBOLS

EXISTING	PROPOSED	DESCRIPTION
Ø		GAS VALVE
		PAD MOUNT TRANSFORMER
Р		POWER VAULT (SIZE VARIES)
-0-		UTILITY POLE
\leftarrow		UTILITY POLE ANCHOR
		UTILITY PEDESTAL
Т		TELEPHONE VAULT (SIZE VARIES)
\bigcirc		TELEPHONE MANHOLE (SIZE VARIES)

SURVEY SYMBOLS

EXISTING	PROPOSED	DESCRIPTION
Δ		CONTROL POINT
•		MONUMENT (IN CASE)
		MONUMENT (SURFACE)
-		BENCH MARK

SANITARY/STORM SEWER SYMBOLS

EXISTING	PROPOSED	<u>DESCRIPTION</u> STORM DRAIN MANHOLE/TYPE 2 CATCH BASIN (ACTUAL DIMENSION SHOWN FOR
		PROPOSED)
П		STORM DRAIN CATCH BASIN, CONCRETE INLET, OR YARD/AREA DRAIN (ACTUAL
	_	DIMENSION SHOWN FOR PROPOSED)
S		SANITARY SEWER MANHOLE (ACTUAL DIMENSION SHOWN FOR PROPOSED)
0		CLEAN OUT (SAN. SEWER OR STORM)

SURFACE FEATURES/LANDSCAPING

EXISTING	PROPOSED	DESCRIPTION MAIL BOX (NOTED)
Д		SIGN
		ROCK WALL
		SHRUB
NOT	_	TREE (CONIFER)
NOT	ĒD	TREE (DECIDUOUS)
		ROCK/BOULDER

 CENTER LANE LINE
CROSS WALK MARKING
STOP BAR

DESCRIPTION

GENERAL NOTES:

- 1. ALL MATERIALS AND WORKMANSHIP SHALL BE FURNISHED AND SUPPLIED IN ACCORDANCE WITH THE 2024 WASHINGTON STATE UNLESS OTHERWISE SPECIFICALLY NOTED.
- COORDINATE WITH ALL UTILITY COMPANIES IN ORDER TO ASSURE THAT ALL LINES, PIPES, POLES AND OTHER APPURTENANCES ARE PROPERLY LOCATED, SECURED, AND/OR PROTECTED. BURIED UTILITIES (WHERE KNOWN) ARE SHOWN IN THEIR APPROXIMATE LOCATION. THE CONTRACTOR SHALL HAVE UTILITIES VERIFIED ON THE GROUND PRIOR TO ANY CONSTRUCTION. NOTIFY THE UNDERGROUND UTILITIES LOCATE CENTER: CALL #811.
- 3. THE CONTRACTOR SHALL HAVE A COPY OF THESE PLANS, ANY ADDENDA, CHANGE ORDERS AND THE CONTRACT SPECIFICATIONS ON THE JOB SITE WHENEVER CONSTRUCTION IS IN PROGRESS.
- 4. THE CONTRACTOR SHALL PROMPTLY NOTIFY THE ENGINEER IN THE EVENT OR DISCOVERY OF UNSUITABLE SOILS OR HIGH GROUND
- 5. WHEREVER PLANS REFER TO "SAWCUT" OF ASPHALT CONCRETE PAVEMENT OR OIL MAT, OR CONCRETE SURFACE, THE CONTRACTOR
- 6. THE CONTRACTOR SHALL MAINTAIN A CLEAN LEGIBLE SET OF
- 7. THE CONTRACTOR SHALL BE RESPONSIBLE FOR ALL TRAFFIC CONTROL IN ACCORDANCE WITH MUTCD. PRIOR TO DISRUPTION OF ANY TRAFFIC, TRAFFIC CONTROL PLANS SHALL BE PREPARED AND SUBMITTED TO THE CITY FOR APPROVAL. NO WORK SHALL COMMENCE UNTIL ALL APPROVED TRAFFIC CONTROL IS IN PLACE.
- PROTECTION OF THE ENVIRONMENT: NO CONSTRUCTION RELATED ACTIVITY SHALL CONTRIBUTE TO THE DEGRADATION OF THE ENVIRONMENT, ALLOW MATERIAL TO ENTER SURFACE OR GROUND WATERS, OR ALLOW PARTICULATE EMISSIONS TO THE ATMOSPHERE, WHICH EXCEED STATE OR FEDERAL STANDARDS. ANY ACTIONS THAT POTENTIALLY ALLOW A DISCHARGE TO STATE WATERS MUST HAVE PRIOR APPROVAL OF THE WASHINGTON STATE DEPARTMENT OF ECOLOGY.

- DEPARTMENT OF TRANSPORTATION STANDARD SPECIFICATIONS FOR ROAD, BRIDGE AND MUNICIPAL CONSTRUCTION AND CITY OF MEDINA PUBLIC WORKS STANDARDS, AND THESE CONTRACT DOCUMENTS
- 2. THE CONTRACTOR SHALL BE RESPONSIBLE TO CONTACT AND
- WATER CONDITIONS OR DISCREPANCIES FROM THE PLANS.
- SHALL PERFORM A "NEAT LINE CUT" PER SPECIFICATIONS.
- RECORD DRAWINGS AND PROVIDE A SET TO THE OWNER PRIOR TO DEMOBILIZATION OF THE SITE. SEE SPECIFICATIONS.

SHEET INDEX

28 - 29

SHEET	NO.	DESCRIPTION
COVER	-	
SHEET	1	ABBEVIATIONS, SYMBOL LEGEND AND GENERAL NOTES
SHEET	2	SURVEY AND ALIGNMENT CONTROL TABLES
SHEET	3 - 4	TEMPORARY EROSION AND SEDIMENT CONTROL DETAILS
SHEET	5 - 10	CURB RAMP PLANS (SCHEDULE A)
SHEET	11 - 14	CURB RAMP PLANS (SCHEDULE B)
SHEET	15	CURB RAMP PLANS (SCHEDULE C)
SHEET	16 - 17	OVERLAY PLANS (SCHEDULE C)
SHEET	18 - 19	CURB RAMP DETAILS
SHEET	20 - 22	ROADWAY DETAILS
SHEET	23 - 25	STORM DETAILS
SHEET	26 - 27	CHANNELIZATION AND SIGNING DETAILS

TRAFFIC CONTROL DETAILS




1130 RAINIER AVENUE SOUTH, SUITE 300 SEATTLE, WASHINGTON 98144 (206) 284-0860





CITY OF MEDINA 2024 ADA **IMPROVEMENTS &**

OVERLAY

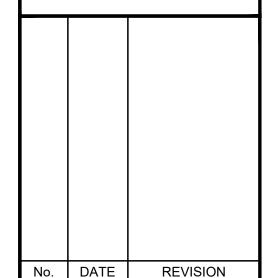

ISSUED FOR:


BID SET

ISSUE DATE:	APR 2024
APPROVED BY:	BLS
CHECKED BY:	BLS
DRAWN BY:	MAN
DESIGNER:	MAN
G & O JOB NO.:	24432.00
FILE:	LEGEND.DWG

TWO INCHES AT FULL SCALE. IF NOT, SCALE ACCORDINGLY

ABBREVIATIONS, SYMBOL LEGEND AND GENERAL NOTES

SHEET: 1

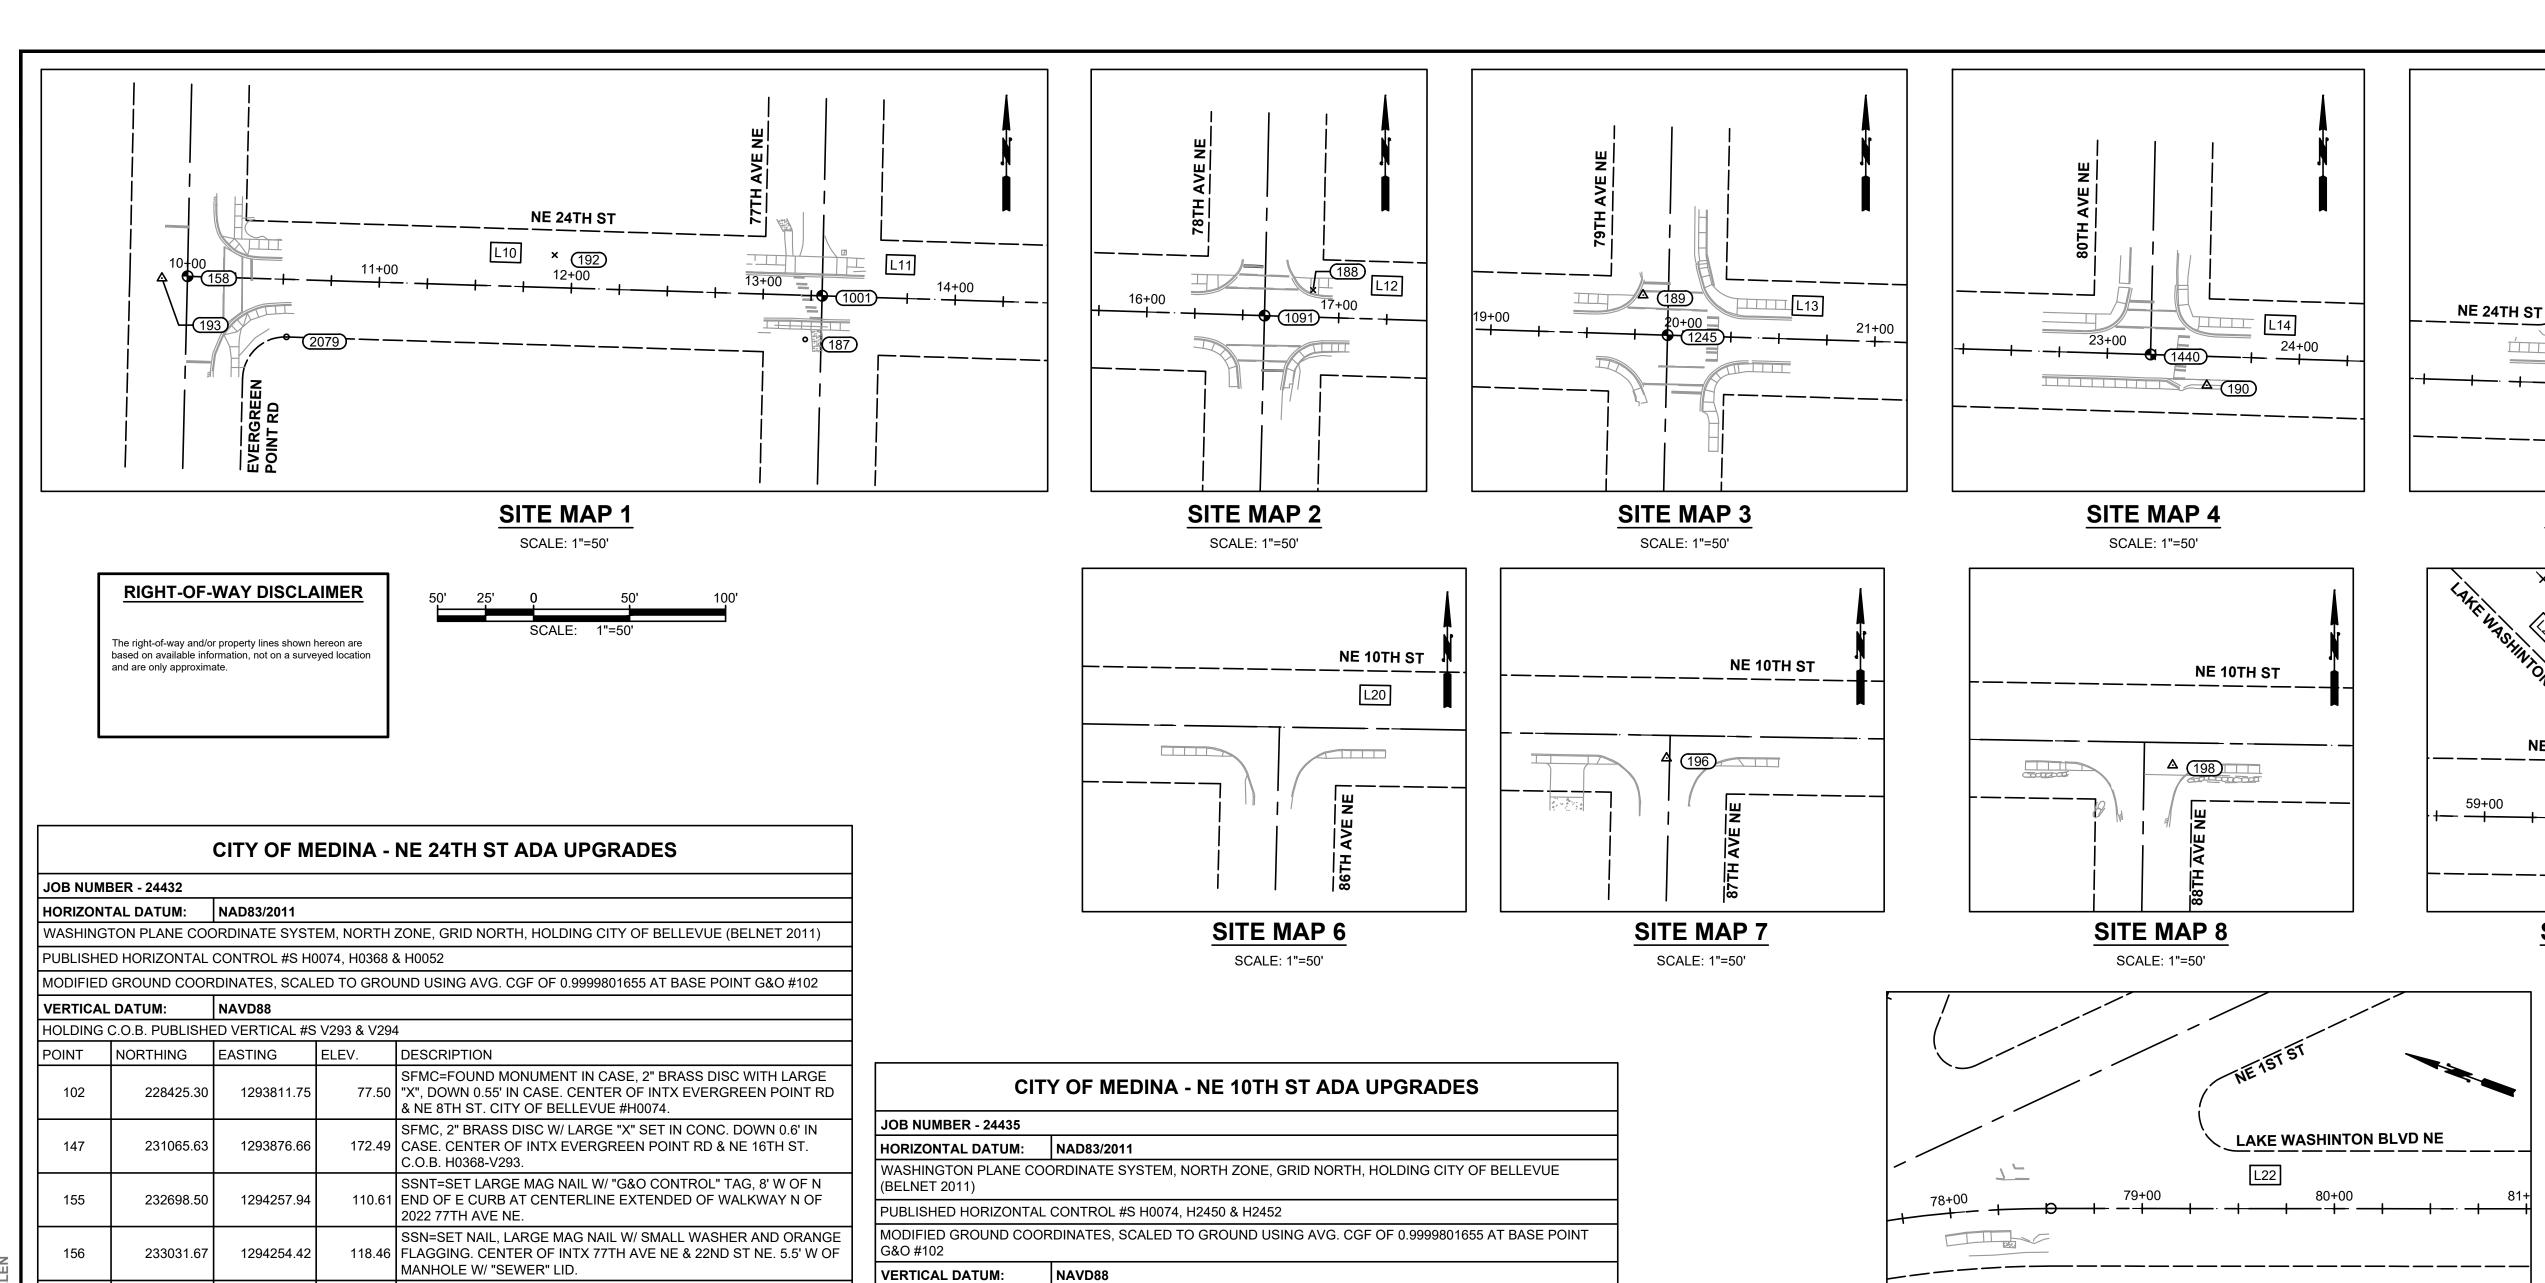

NAVD88

EASTING

1293811.75

1296478.16

1296452.64

1296454.32

1296804.13

1297368.06

HOLDING C.O.B. PUBLISHED VERTICAL #S V615 & V617

INORTHING

228425.30

228721.49

228325.38

228979.54

229003.98

228961.4

228474.80

228956.5

228668.44

228456.37

228980.84

228323.04

229637.64

POINT

112

194

201

1582

SFMC, LEAD W/ TACK OR BRASS PIN IN CONC. DOWN 0.5' IN CASE

CENTER OF INTX NE 22ND ST & EVERGREEN POINT RD. NO LID.

SFMC, 3/8" BRASS PLUG W/ PUNCH SET IN CONCRETE. DID NOT

SSRC=SET 5/8" REBAR W/ RED "G&O CONTROL" CAP, DOWN 0.15'

SFNT=FOUND NAIL W/ TAG, W/ "1 ALLIANCE GEOMATICS" TAG. NE

WALL EXTENDED N AT NW PROPERTY CORNER OF GOLF COURSE.

SSNT, 1' N OF S BACK OF WEDGE CURB ALONG NE 24TH ST. INTX

BELOW F/G. W OF TRAIL. S OF S BACK OF WALK OF NE 24TH ST.

126.42 INTX NE 24TH ST & 77TH AVE NE. 2.4' N OF NW CORNER OF "INDIAN

TRAIL" POST. 16' WSW OF "25 MPH SPEED LIMIT" SIGN.

129.24 QUADRANT INTX NE 24TH ST & 77TH AVE NE. IN SIDEWALK. 3.2'

SSNT, 4' E OF W CURB FLOW LINE IN CURB RETURN. NW

112.64 QUADRANT OF NE 24TH ST & 79TH AVE NE. N BACK OF SIDEWALK

SSNT, IN S WEDGE CURB FLOW LINE OF NE 24TH ST. SE

82.04 QUADRANT INTX NE 24TH ST & 80TH AVE NE. NORTH TO SOUTH

50.95 NE 24TH ST & 82ND AVE NE. AT 82ND CENTERLINE EXTENDED TO

129.00 ACROSS FROM #7617. 8' W OF HYDRANT. 1.75' N OF S EDGE OF

SFNT, NAIL W/ "TERRANE" TAG. N SIDEWALK OF NE 24TH ST.

SSNT, W SIDE TOP OF WEDGE CURB AT INTX NE 24TH ST &

EVERGREEN POINT RD. AT CENTERLINE NE 24TH ST EXTENDED.

SFMC, 3/8" BRASS PLUG, DOWN 1.2' IN CASE. INTX NE 24TH ST &

SFMC, 3/8" BRASS PLUG W/ PUNCH SET IN CONC. DOWN 1.8' IN

SFMC, 3/8" BRASS PLUG W/ PUNCH SET IN CONC. DOWN 1.45' IN

SFMC, 3/8" BRASS PLUG W/ PUNCH SET IN CONC. DOWN 0.7' IN

SFMC, 3/8" BRASS PLUG W/ PUNCH SET IN CONC. DOWN 1.2' IN

SFMC, 3/8" BRASS PLUG W/ PUNCH SET IN CONC. DOWN 1.2' IN

131.25 SFRC, 1/2" REBAR W/ ORANGE PLASTIC "TERRANE 1502" CAP.

WSW OF 90° ANGLE POINT IN FRONT OF WALK.

SFMC, 2" BRASS DISC W/ "X" IN CONC. DOWN 0.??' IN CASE.

131.24 CENTER OF INTX EVERGREEN POINT RD & NE 24TH ST. CITY OF

124.90 GET MEASURE DOWN. CENTER OF INTX NE 22ND ST & 78TH AVE

BELLEVUE "H0052-V294."

NE 24TH ST EXTENDED TO E.


127.66 CASE. INTX NE 24TH ST & 78TH AVE NE.

110.82 CASE. INTX NE 24TH ST & 79TH AVE NE.

110.96 CASE. INTX NE 22ND ST & 79TH AVE NE.

CASE. INTX NE 24TH ST & 80TH AVE NE.

CASE. INTX NE 24TH ST & 82TH AVE NE.

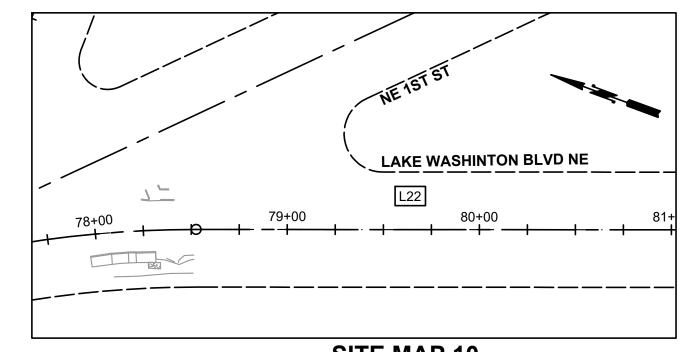

SITE MAP 10

SCALE: 1"=50'

NE 24TH STREET - CONSTRUCTION CENTERLINE ALIGNMENT												
SEGMENT	BEGIN STATION	BEGIN NORTHING	BEGIN EASTING	END STATION	END NORTHING	END EASTING	DISTANCE	BEARING	RADIUS	TANGENT	CURVE LENGTH	DELTA
L10	10+00.00	233,705.94	1,293,941.40	13+30.68	233,695.70	1,294,271.92	330.68	S88°13'33"E				
L11	13+30.68	233,695.70	1,294,271.92	16+61.35	233,685.44	1,294,602.42	330.66	S88°13'18"E				
L12	16+61.35	233,685.44	1,294,602.42	19+92.00	233,675.26	1,294,932.92	330.65	S88°14'08"E				
L13	19+92.00	233,675.26	1,294,932.92	23+22.54	233,665.14	1,295,263.31	330.54	S88°14'45"E				
L14	23+22.54	233,665.14	1,295,263.31	28+28.53	233,649.29	1,295,769.05	505.99	S88°12'17"E				
L15	28+28.53	233,649.29	1,295,769.05	29+28.53	233,646.16	1,295,869.00	100.00	S88°12'17"E				

	NE 10TH ST - CONSTRUCTION CENTERLINE ALIGNMENT											
SEGMENT	BEGIN STATION	BEGIN NORTHING	BEGIN EASTING	END STATION	END NORTHING	END EASTING	DISTANCE	BEARING	RADIUS	TANGENT	CURVE LENGTH	DELTA
L20	50+00.00	228,980.00	1,296,951.41	62+09.46	228,960.53	1,298,160.71	1,209.46	S89°04'39"E				

LAKE WASHINGTON BOULEVARD - CONSTRUCTION CENTERLINE ALIGNMENT												
SEGMENT	BEGIN STATION	BEGIN NORTHING	BEGIN EASTING	END STATION	END NORTHING	END EASTING	DISTANCE	BEARING	RADIUS	TANGENT	CURVE LENGTH	DELTA
L21	75+00.00	229,124.58	1,297,846.52	76+01.48	229,052.90	1,297,918.37	101.48	S45°04'08"E				
C1	76+01.48	229,052.90	1,297,918.37	78+52.51	228,842.92	1,298,052.23			572.96	127.56	251.03	25°06'10'
L22	78+52.51	228,842.92	1,298,052.23	81+52.37	228,561.08	1,298,154.62	299.86	S19°57'58"E				



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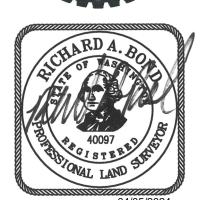


SITE MAP 5

SCALE: 1"=50'


SITE MAP 9

SCALE: 1"=50'





CITY OF MEDINA 2024 ADA **IMPROVEMENTS & OVERLAY**

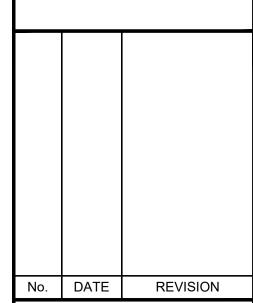

ISSUED FOR:

BID SET

ISSUE [DATE:	APR 2024
APPRO	VED BY:	BLS
CHECKI	ED BY:	RAB
DRAWN	BY:	BPH
DESIGN	IER:	MAN
G & O J	OB NO.:	24432.00
FILE:	SURVEY	CONTROL.DWG
•		

TWO INCHES AT FULL SCALE IF NOT, SCALE ACCORDINGLY

GENERAL

SURVEY AND ALIGNMENT CONTROL TABLES

OF: **29**

193

1001

1091

1245

1246

1440

2079

1293925.21

1293941.40

1294586.14

1294263.07

1294627.68

1294920.15

1295292.56

1295768.74

1294133.00

1293928.00

1294271.92

1294602.42

1294932.92

1294916.48

1295263.31

1295769.05

1293993.00

233045.81

233705.94

233024.78

233673.03

233698.74

233696.14

233649.13

233632.76

233717.00

233704.90

233695.70

233685.44

233675.26

233014.30

233665.14

233649.29

233674.30

SFMC=FOUND MONUMENT IN CASE, 2" BRASS DISC WITH

EVERGREEN POINT RD & NE 8TH ST. CITY OF BELLEVUE

SSN=SET NAIL, MAG NAIL, 1' W OF E BACK OF SIDEWALK,

SFMC, CENTERLINE OF 84TH AVE NE. CITY OF BELLEVUE

SSNT=SET MAG NAIL W/ "G&O CONTROL" TAG, AT W TOP OF WEDGE CURB, SW QUADRANT INTEX 84TH AVE NE &

NE 10TH ST. S END OF HEDGE ROW AT EAST FACE OF

SSN, 60-D NAIL W/ BLUE WHISKERS, DOWN 0.1' IN GRASS.

SSNT, CENTERLINE OF 87TH AVE NE AT N CROSSWALK

LARGE "X", DOWN 0.55' IN CASE. CENTER OF INTX

#0075. NAIL W/ PUNCH SET IN CONC, DOWN 0.95' IN CASE.

109.30 2' E OF FACE OF BRICK WALL AT S END, SE CORNER OF

NW CORNER OF LOT 826 84TH AVE NE.

1015 84TH AVE NE.

8420 NE 10TH ST.


121.92 BAR. INTX NE 10TH ST & 87TH AVE NE.

ST. W OF DRIVEWAY TO 9027 NE 1ST ST. CITY OF BELLEVUE: HORIZONTAL "H2450"; VERTICAL "V615." SFMC, 1/4" BRASS PIN SET IN CONCRETE, DOWN 1.25' IN CASE. AT INTX LAKE WASHINGTON BLVD NE & NE 12TH 1297307.92 ST. CITY OF BELLEVUE: HORIZONTAL "H2452"; VERTICAL

SFMC, TACK IN LEAD, SET IN CONCRETE. DOWN 0.8' IN 1297344.06 CASE. INTX 87TH AVE NE & NE 9TH ST. SSNT, SE QUADRANT OF INTX NE 10TH ST & 88TH AVE NE. 104.35 IN S LINE OF N CROSSWALK BAR. 9.5' NW OF CAMERA 1297685.86 SFMC, 3/8" BRASS PLUG W/ PUNCH SET IN CONCRETE. 1297666.56 130.35 DOWN 1.05' IN CASE. AT CENTERLINE 88TH AVE NE, AT 934 88TH AVE NE. SFMC, 3/8" BRASS PLUG W/ PUNCH SET IN CONCRETE. 1297620.95 139.62 DOWN 1.95' IN CASE. AT CENTER OF 88TH AVE NE CULDESAC. SSNT, NE QUADRANT NE 10TH ST & NE 1ST ST. IN N LINE OF S CROSSWALK BAR BETWEEN NE & NW QUADRANTS 94.12 OF INTX. 6' SW OF FACE OF EASTERLY CURB AT TOP 1298013.04 RAMP OF DRIVEWAY CUT FOR 1020 LAKE WASHINGTON SFM=FOUND SURFACE MONUMENT, 2" BRASS CITY OF BELLEVUE MON W/ PUNCH. TOP OF S CURB OF NE 1ST 1298646.83

STANDARD EROSION AND SEDIMENT CONTROL (TESC) NOTES

- 1. ALL REQUIRED SEDIMENTATION/EROSION CONTROL FACILITIES MUST BE IN OPERATION PRIOR TO LAND CLEARING AND/OR OTHER CONSTRUCTION TO ENSURE THAT SEDIMENT LADEN WATER DOES NOT ENTER THE NATURAL DRAINAGE SYSTEM. ALL EROSION AND SEDIMENT FACILITIES SHALL BE MAINTAINED IN A SATISFACTORY CONDITION UNTIL SUCH TIME THAT CLEARING AND/OR CONSTRUCTION IS COMPLETED AND THE POTENTIAL FOR ON-SITE EROSION HAS PASSED. THE IMPLEMENTATION, MAINTENANCE, REPLACEMENT AND ADDITIONS TO EROSION/SEDIMENTATION CONTROL SYSTEMS SHALL BE THE RESPONSIBILITY OF THE CONTRACTOR.
- 2. THE CONTRACTOR SHOULD ANTICIPATE THAT EROSION AND SEDIMENTATION CONTROL FACILITIES WILL BE NECESSARY TO ENSURE COMPLETE SILTATION CONTROL ON THE PROPOSED SITE. DURING THE COURSE OF CONSTRUCTION, IT SHALL BE THE OBLIGATION AND RESPONSIBILITY OF THE CONTRACTOR TO ADDRESS ANY NEW CONDITIONS THAT MAY BE CREATED BY HIS ACTIVITIES AND TO PROVIDE ADDITIONAL FACILITIES AS MAY BE NEEDED TO PROTECT ADJACENT PROPERTIES AND THE WATER QUALITY OF THE RECEIVING DRAINAGE SYSTEM.
- 3. AT NO TIME SHALL MORE THAN SIX INCHES OF SEDIMENT BE ALLOWED TO ACCUMULATE WITHIN A CATCH BASIN. THE CONTRACTOR SHALL BE RESPONSIBLE FOR REMOVING AND DISPOSING OF THE SEDIMENT. ALL CATCH BASINS, CONVEYANCE LINES AND DITCHES SHALL BE CLEANED PRIOR TO PAVING.
- 4. THE CONTRACTOR SHALL REMOVE AND WASTEHAUL MATERIAL DROPPED, WASHED OR TRACKED FROM VEHICLES ONTO THE TOWN RIGHT-OF-WAY OR INTO THE EXISTING STORM DRAINAGE SYSTEM. DEBRIS SHALL NOT BE WASHED INTO THE STORM DRAINAGE SYSTEM.
- 5. TEMPORARY EROSION CONTROL FACILITIES SHALL BE INSPECTED WEEKLY AND MAINTAINED WITHIN 24 HOURS FOLLOWING A STORM EVENT. SEDIMENT SHALL BE REMOVED TO INSURE THE FACILITIES WILL FUNCTION PROPERLY. THE FACILITIES SHALL BE SATISFACTORILY MAINTAINED UNTIL CONSTRUCTION IS COMPLETED AND THE POTENTIAL FOR ON-SITE EROSION HAS PASSED.
- 6. ALL STORM DRAIN INLETS MADE OPERABLE DURING CONSTRUCTION SHALL BE PROTECTED SO THAT STORMWATER RUNOFF SHALL NOT ENTER THE CONVEYANCE SYSTEM WITHOUT FIRST BEING FILTERED OR OTHERWISE TREATED TO REMOVE SEDIMENT.
- 7. NO DISTURBED SOIL SHALL REMAIN UNSTABILIZED FOR MORE THAN TWO DAYS.

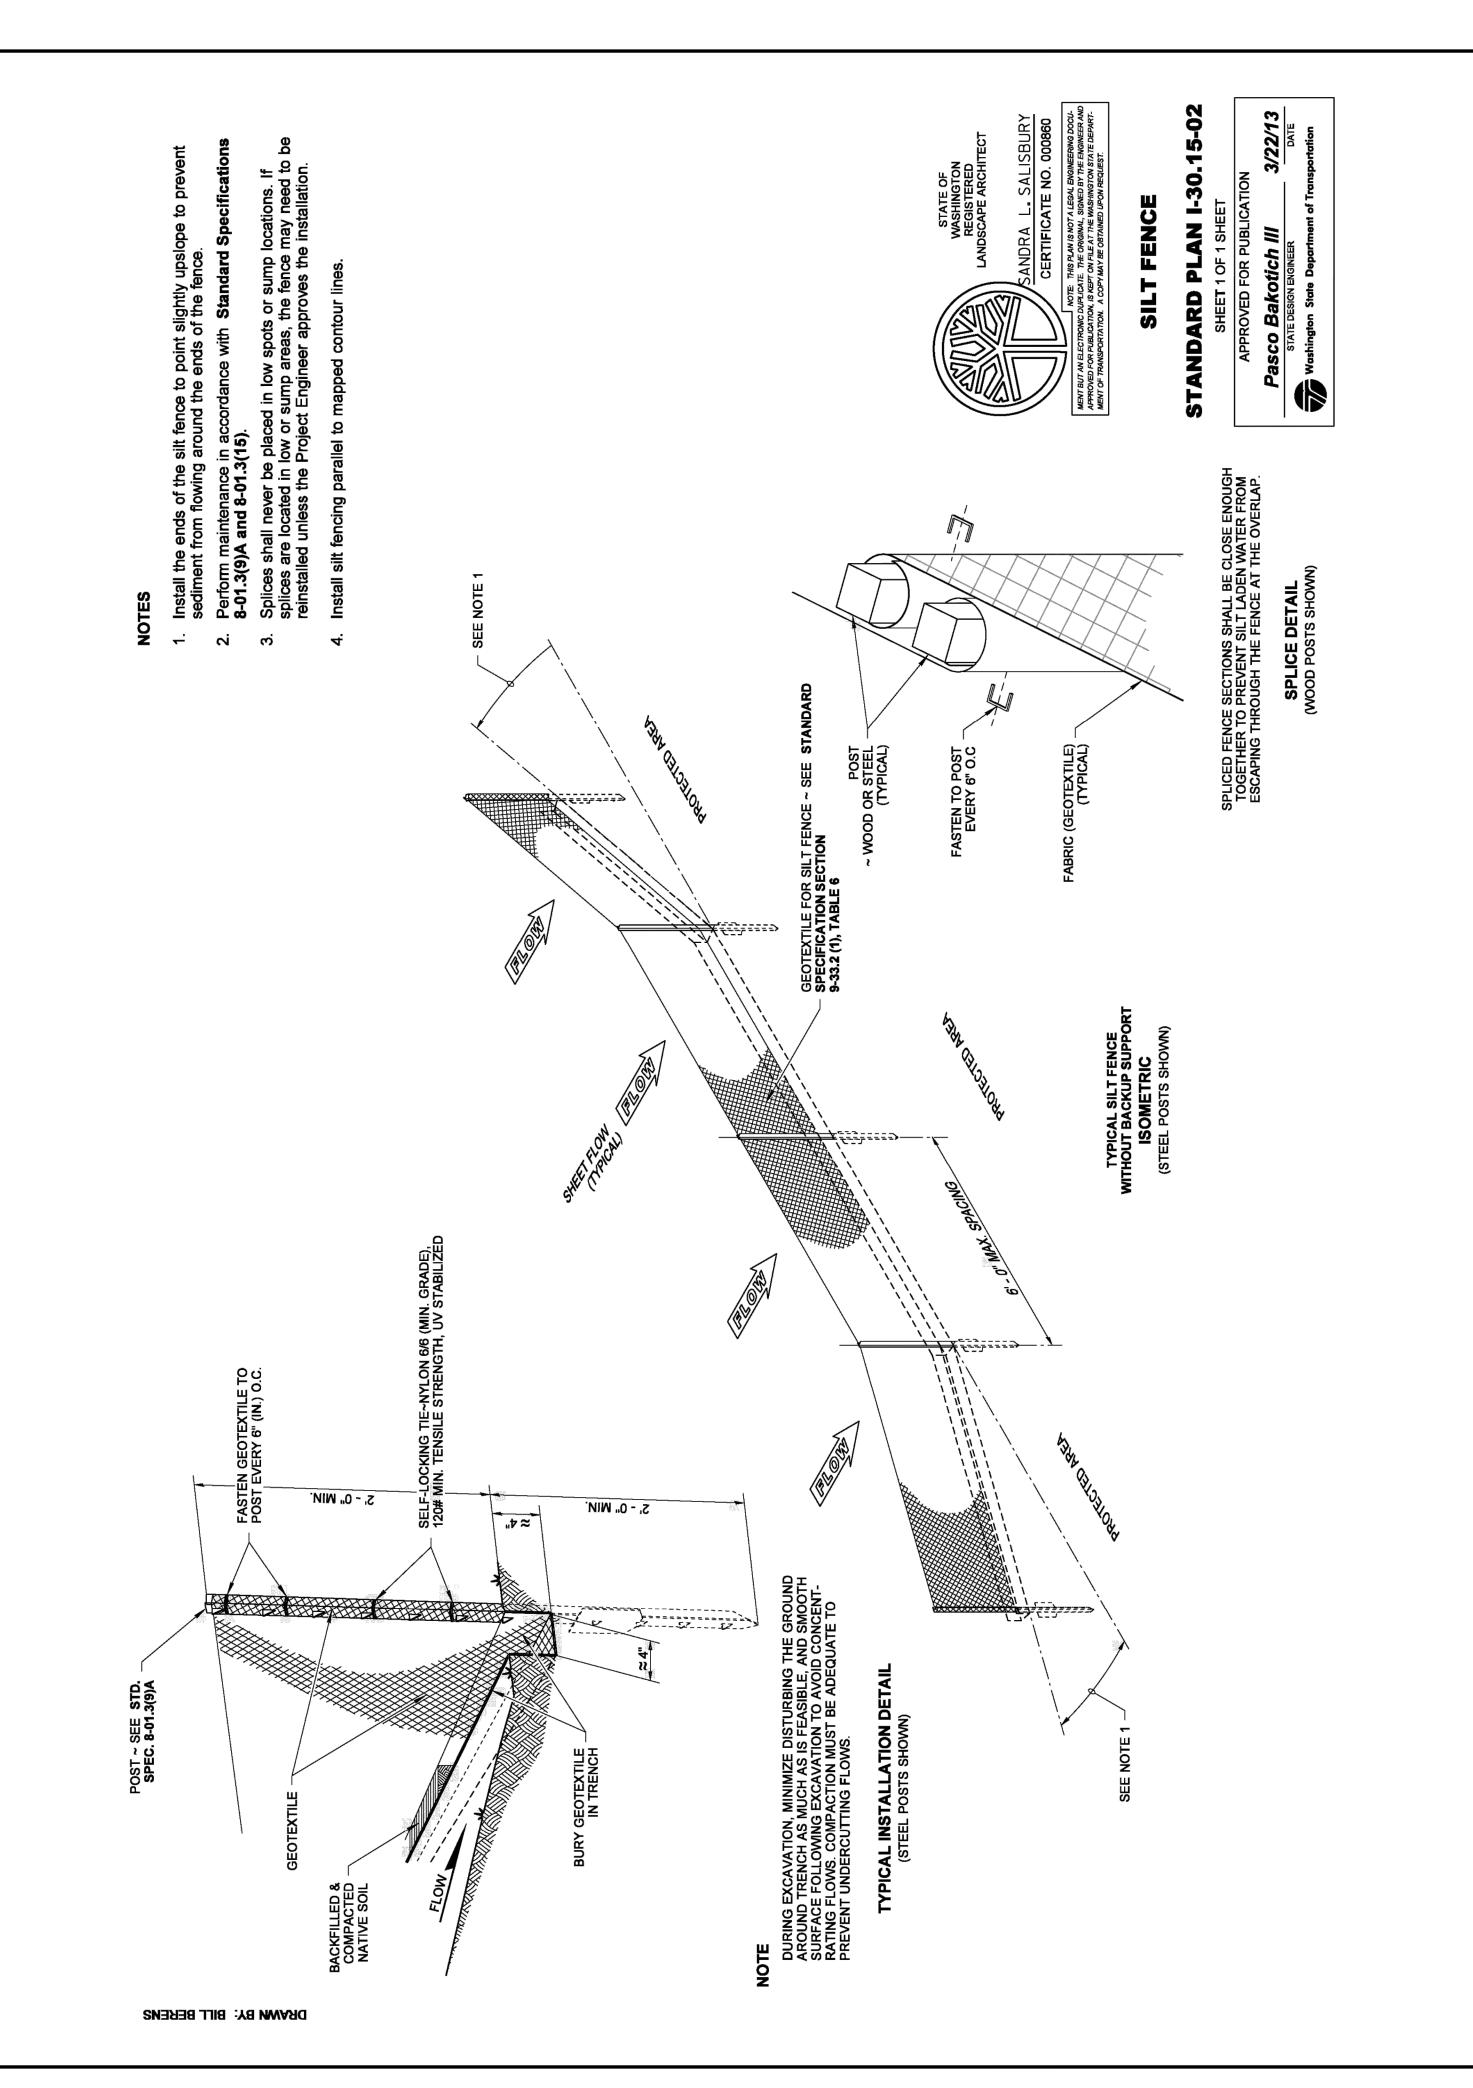



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CITY OF MEDINA 2024 ADA **IMPROVEMENTS & OVERLAY**

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BID SET


ISSUE	DATE:	APR 2024
APPRO	OVED BY:	BLS
CHEC	KED BY:	BLS
DRAW	N BY:	MAN
DESIG	NER:	MAN
G & O .	JOB NO.:	24432.00
FILE:	EROSIO	N CONTROL.DWG

TEMPORARY EROSION AND SEDIMENT **CONTROL DETAILS**

OF: **29**



DRAWN BY: LISA CYFORD

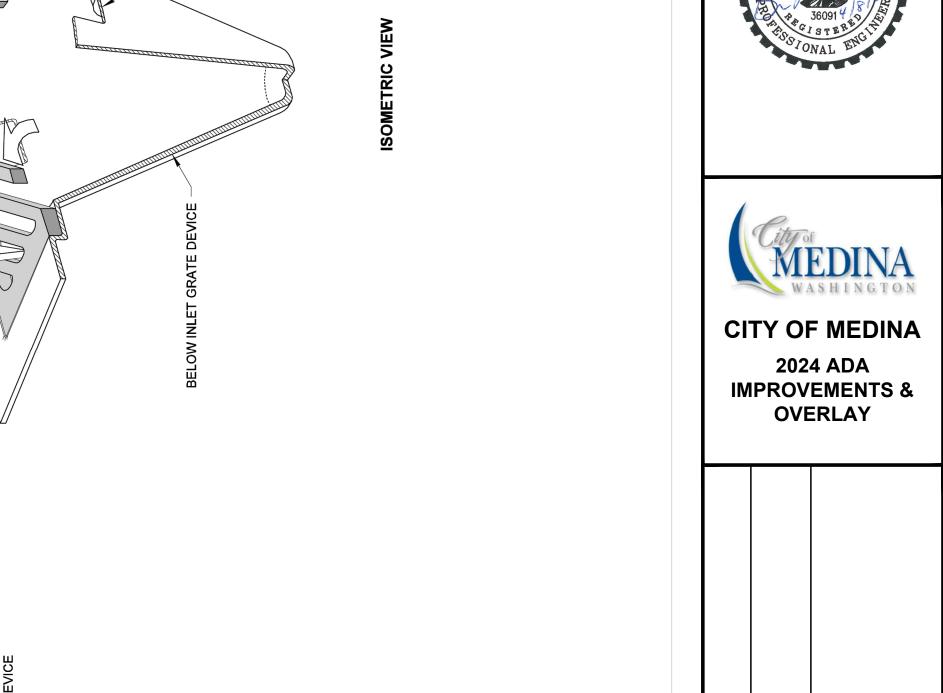

STORM DRAIN
INLET PROTECTION
STANDARD PLAN I-40.20SHEET 1 OF 1 SHEET
APPROVED FOR PUBLICATION



Gray & Osborne, Inc.

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No. DATE REVISION


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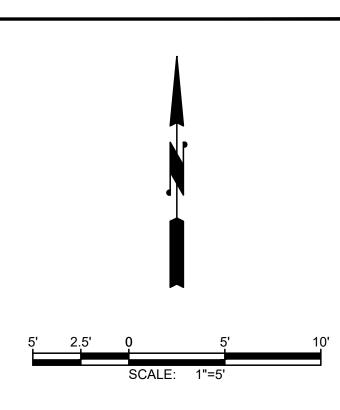
BID SET

APR 2024 ISSUE DATE: BLS APPROVED BY: CHECKED BY: BLS MAN DRAWN BY: MAN DESIGNER: 24432.00 G & O JOB NO.: FILE: EROSION CONTROL.DWG

TEMPORARY EROSION AND SEDIMENT **CONTROL DETAILS**

SHEET: 4



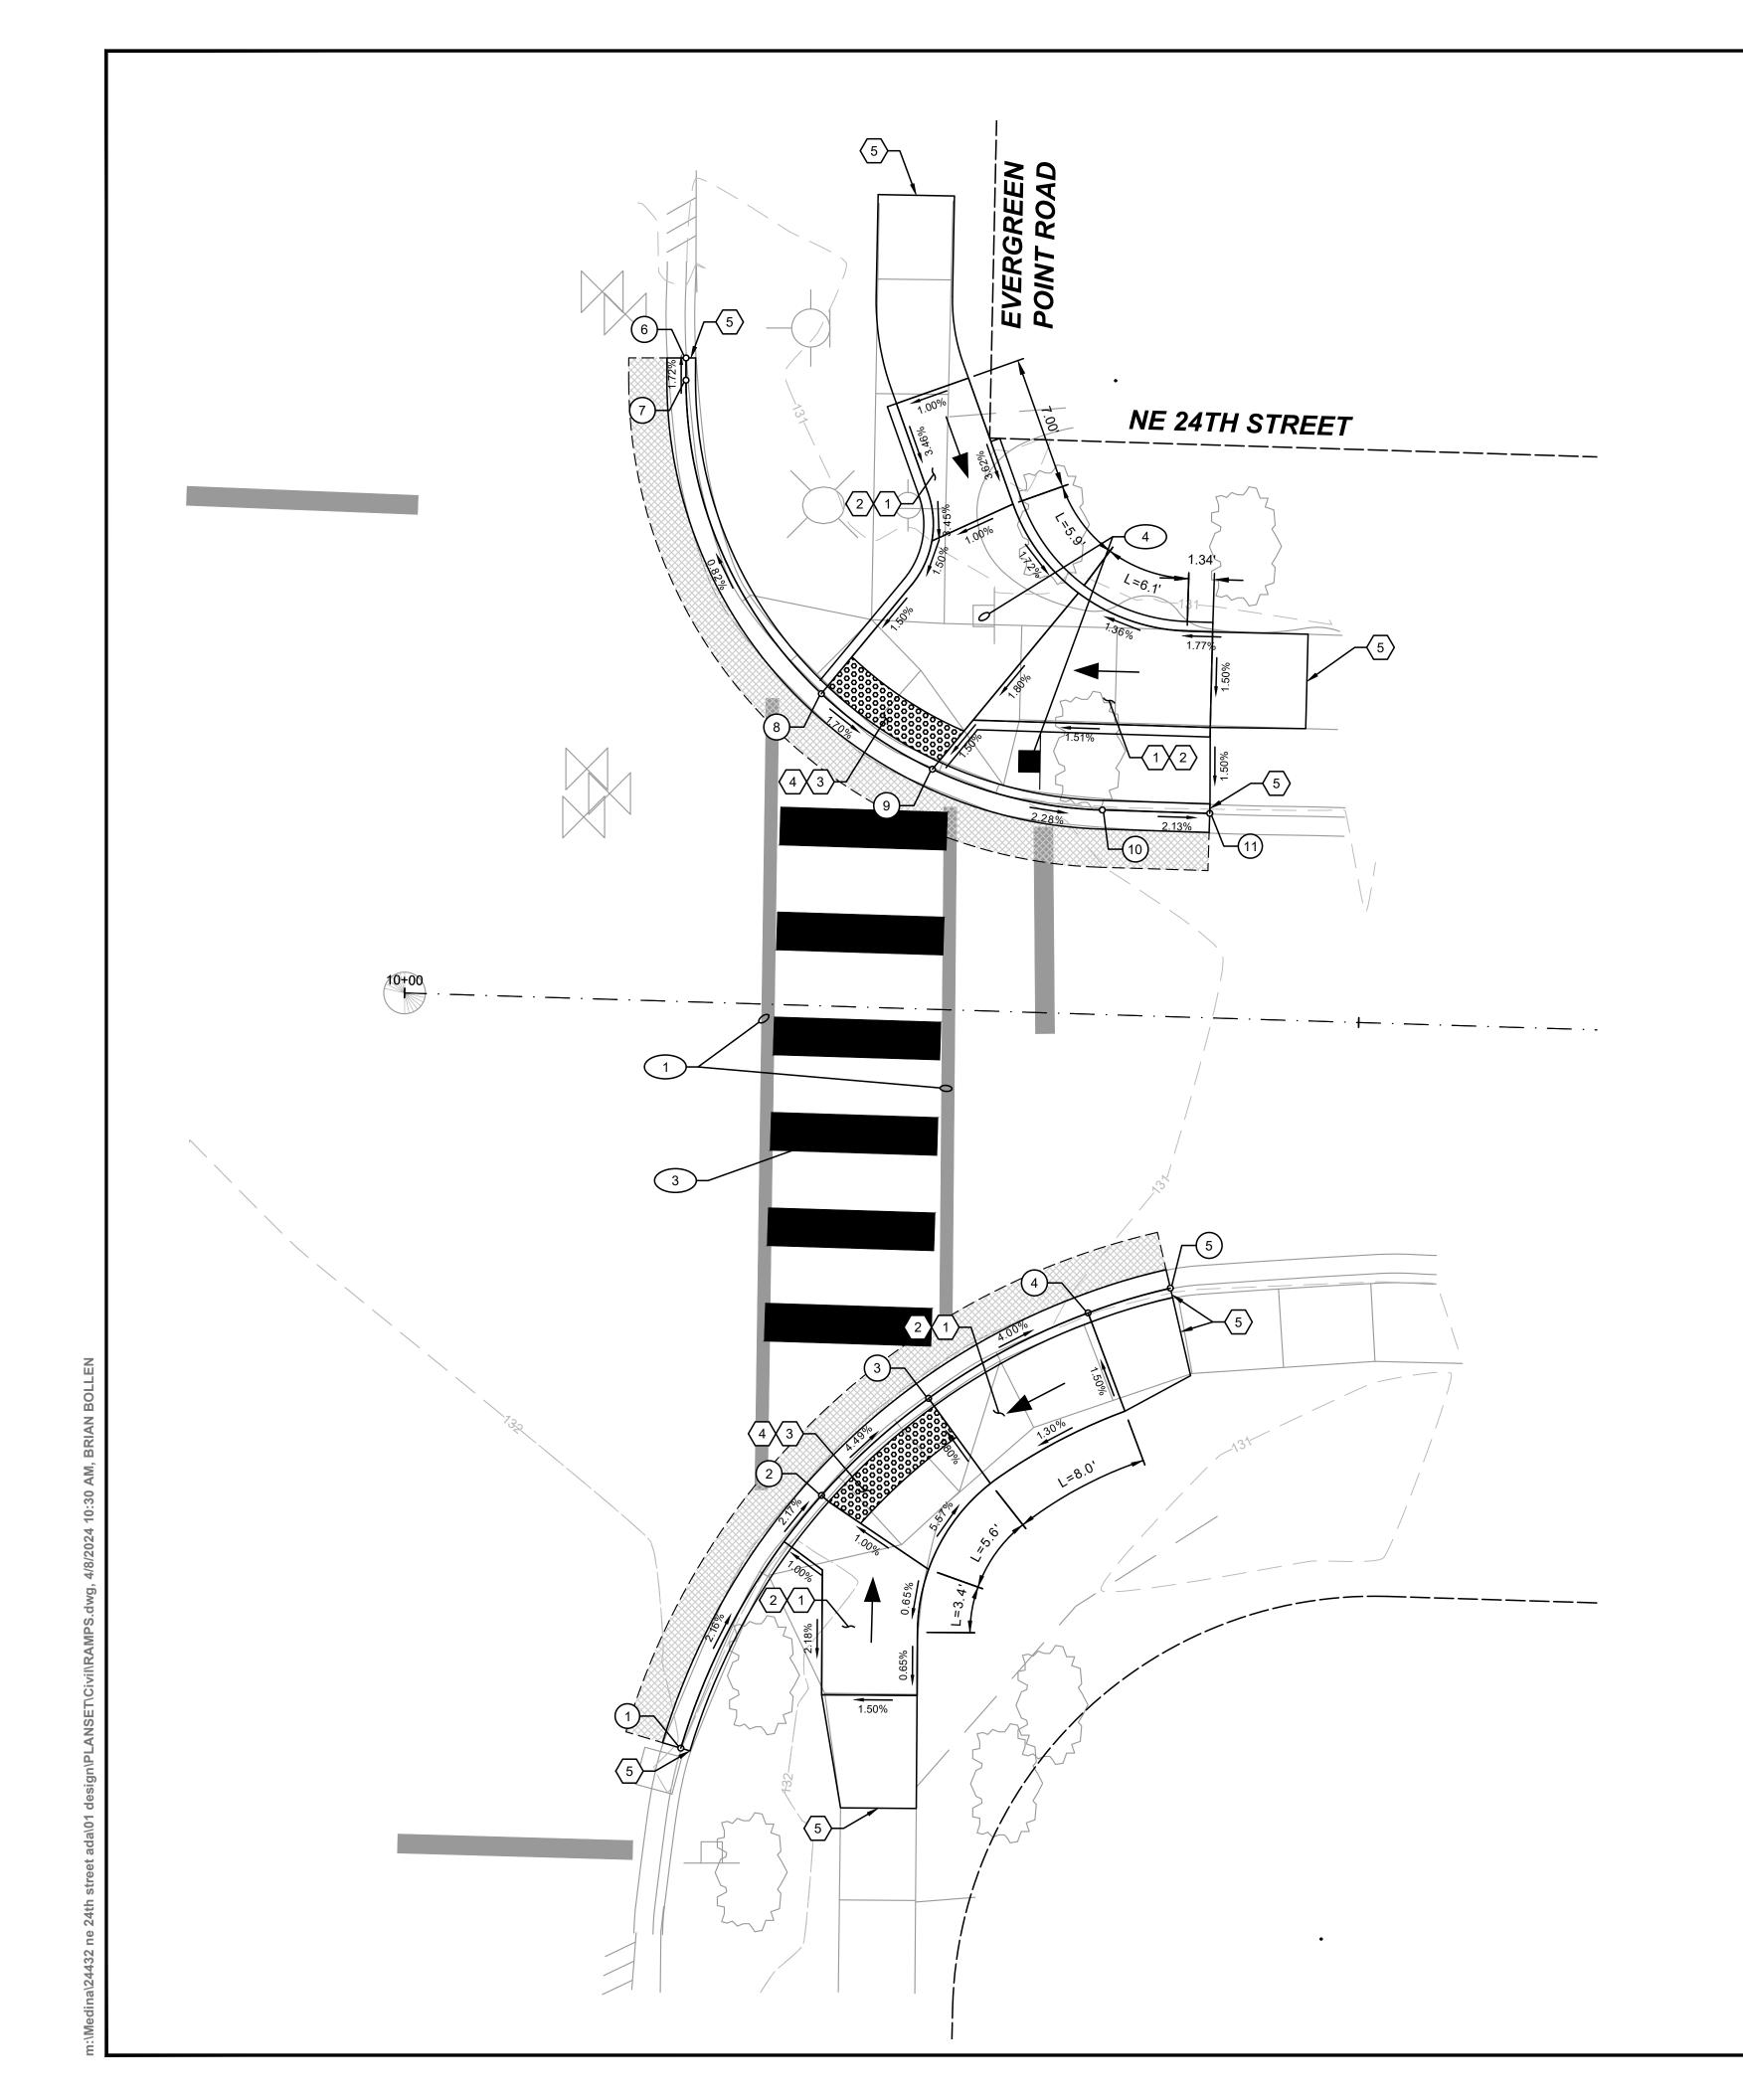

- 1. PAVEMENT REPAIR PER TYPICAL ROADWAY CROSS SECTION AND DETAILS, SHEETS 21.
- 2. CURB TYPE AS INDICATED ON THE PLAN. SEE DETAILS, SHEET 22.
- 3. SEE CEMENT CONCRETE SIDEWALK AND JOINTS DETAIL, SHEET 22.
- 4. SEE CURB RAMPS AND DETECTABLE WARNING SURFACE DETAILS, SHEETS 18 AND 19.
- 5. MATCH EXISTING SIDEWALK WIDTH UNLESS INDICATED OTHERWISE.
- 6. ONCE CURB STRING LINES AND/OR FORMS HAVE BEEN SET BY THE CONTRACTOR, THE CONTRACTING AGENCY WILL REVIEW AND APPROVE THE CURB LINES PRIOR TO POURING. THE CONTRACTOR SHALL ANTICIPATE MINOR FIELD ADJUSTMENTS WILL BE REQUIRED AT NO ADDITIONAL COST. THE CONTRACTOR SHALL STRUCTURE HIS BID ACCORDINGLY.

CONSTRUCTION NOTES

- 1. CONTRACTOR TO FIELD VERIFY AND ADJUST RAMP LENGTH TO MEET RAMP SLOPE REQUIREMENTS PER DETAILS. THE CURB RAMP MAXIMUM RUNNING SLOPE AT THE BACK OF THE RAMP SHALL NOT REQUIRE THE RAMP LENGTH TO EXCEED 15-FEET.
- 2. CURB RAMP. CROSS SLOPE SHALL NOT EXCEED 2.0%, LONGITUDINAL SLOPE SHALL NOT EXCEED 8.33%.
- 3. LANDING. CROSS SLOPES SHALL NOT EXCEED 2.0%.
- 4. DETECTABLE WARNING SURFACE. 2' MIN. ALONG DIRECTION OF TRAVEL, TYP. FOR ALL APPLICATIONS.
- 5. SAWCUT EXISTING CURB AND/OR SIDEWALK TO NEAREST FULL JOINT AND PROVIDE CLEAN EDGE.

CHANNELIZATION & SIGNING NOTES

1. REMOVE EXISTING PAVEMENT MARKINGS/LINES.

CURB RAMPS 1 & 2

PC / MATCH EXISTING

LANDING

LANDING

RAMP TOP

MATCH EXISTING

MATCH EXISTING

PC

LANDING / HIGH POINT

LANDING

MATCH EXISTING

10+15.69

10+22.64

10+28.09

10+36.30

10+40.57

10+13.70

10+13.74

10+21.34

10+27.27

10+36.23

10+41.86

39.09' RT

25.63' RT

20.38' RT

15.64' RT

14.21' RT

33.70' LT

32.54' LT

16.34' LT

12.57' LT

10.71' LT

10.71' LT

| POINT DESCRIPTION: | STATION: | OFFSET: | FL. ELEVATION: | CURB HEIGHT: | CURVE DESCRIPTION: | CENTER:

131.99

131.66

131.32

130.94

130.80

131.08

131.10

131.25

131.13

130.92

130.80

- 2. FURNISH AND INSTALL 24" PLASTIC STOP LINE PER DETAIL SHEET 27.
- 3. FURNISH AND INSTALL 8'-0" PLASTIC CROSSWALK LINE PER DETAIL SHEET 27.
- 4. RELOCATE EXISTING SIGNS. FURNISH AND INSTALL NEW HARDWARE AND POST TYPE ST-2 PER DETAIL SHEET 26. WASTEHAUL EXISTING POST AND FOUNDATION.

6.0"

0.0"

0.0"

6.0"

6.0"

6.0"

6.0"

6.0"

6.0"

0.0" / 6.0"

0.0" / 6.0"

L=36.87'

R=35.00'

L=34.68'

R=22.50'

Δ=88° 18' 02"

Δ=60° 21' 17"

10+49.52

48.05 RT

10+36.23

-33.21 LT



Gray & Osborne, Inc.

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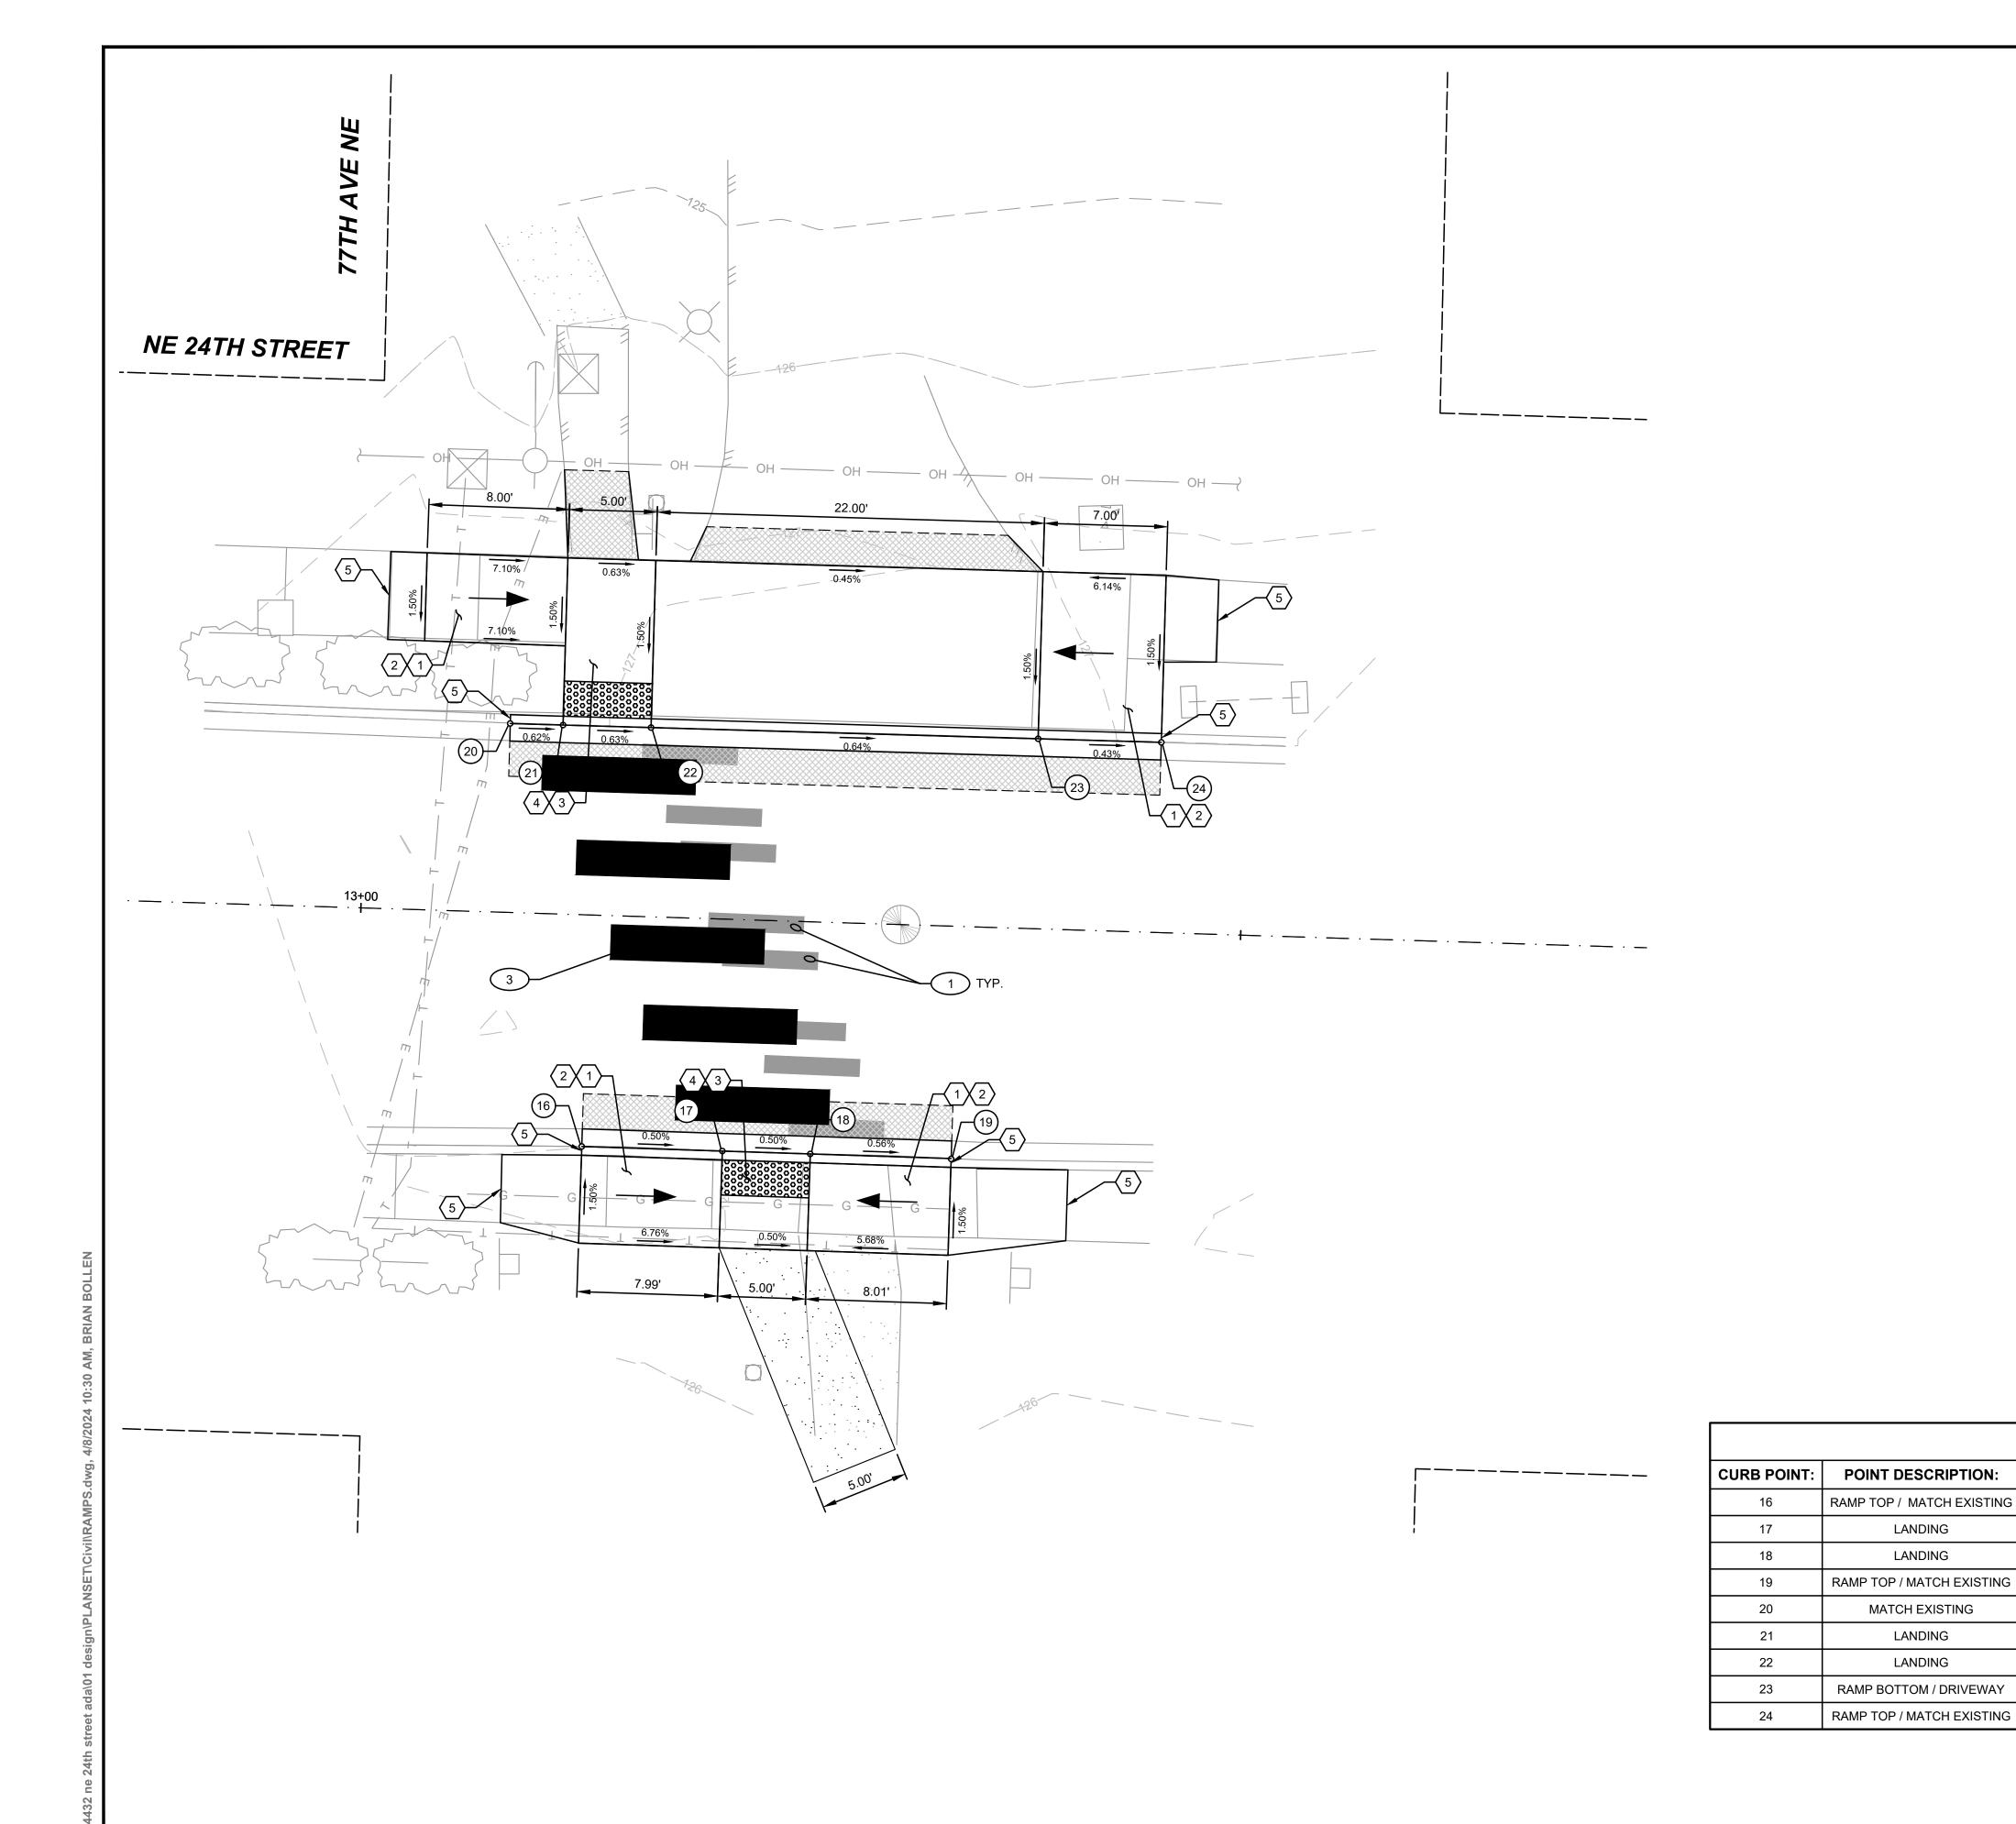
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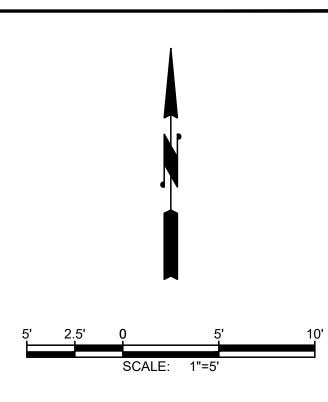
RAMPS.DWG

TWO INCHES AT FULL SCALE IF NOT, SCALE ACCORDINGLY

CURB RAMP PLANS (SCHEDULE A)

OF: **29**





- 1. PAVEMENT REPAIR PER TYPICAL ROADWAY CROSS SECTION AND DETAILS, SHEETS 21.
- 2. CURB TYPE AS INDICATED ON THE PLAN. SEE DETAILS, SHEET 22.
- 3. SEE CEMENT CONCRETE SIDEWALK AND JOINTS DETAIL, SHEET 22.
- 4. SEE CURB RAMPS AND DETECTABLE WARNING SURFACE DETAILS, SHEETS 18 AND 19.
- 5. MATCH EXISTING SIDEWALK WIDTH UNLESS INDICATED OTHERWISE.
- 6. ONCE CURB STRING LINES AND/OR FORMS HAVE BEEN SET BY THE CONTRACTOR, THE CONTRACTING AGENCY WILL REVIEW AND APPROVE THE CURB LINES PRIOR TO POURING. THE CONTRACTOR SHALL ANTICIPATE MINOR FIELD ADJUSTMENTS WILL BE REQUIRED AT NO ADDITIONAL COST. THE CONTRACTOR SHALL STRUCTURE HIS BID ACCORDINGLY.

CONSTRUCTION NOTES

- 1. CONTRACTOR TO FIELD VERIFY AND ADJUST RAMP LENGTH TO MEET RAMP SLOPE REQUIREMENTS PER DETAILS. THE CURB RAMP MAXIMUM RUNNING SLOPE AT THE BACK OF THE RAMP SHALL NOT REQUIRE THE RAMP LENGTH TO EXCEED 15-FEET.
- 2. CURB RAMP. CROSS SLOPE SHALL NOT EXCEED 2.0%, LONGITUDINAL SLOPE SHALL NOT EXCEED 8.33%.
- 3. LANDING. CROSS SLOPES SHALL NOT EXCEED 2.0%.
- 4. DETECTABLE WARNING SURFACE. 2' MIN. ALONG DIRECTION OF TRAVEL, TYP. FOR ALL APPLICATIONS.
- 5. SAWCUT EXISTING CURB AND/OR SIDEWALK TO NEAREST FULL JOINT AND PROVIDE CLEAN EDGE.

CHANNELIZATION & SIGNING NOTES

1. REMOVE EXISTING PAVEMENT MARKINGS/LINES.

CURB RAMPS 3 & 4

126.53

126.50

126.48

126.75

126.73

126.70

126.56

126.53

13.16' RT

13.18' RT

13.18' RT

13.22' RT

10.73' LT

10.74' LT

10.75' LT

10.80' LT

13+12.96

13+20.95

13+25.95

13+33.96

13+08.15

13+11.16

13+16.16

13+38.16

13+45.16

LANDING

LANDING

MATCH EXISTING

LANDING

LANDING

- 2. FURNISH AND INSTALL 24" PLASTIC STOP LINE PER DETAIL SHEET 27.
- 3. FURNISH AND INSTALL 8'-0" PLASTIC CROSSWALK LINE PER DETAIL SHEET 27.
- 4. RELOCATE EXISTING SIGNS. FURNISH AND INSTALL NEW HARDWARE AND POST TYPE ST-2 PER DETAIL SHEET 26. WASTEHAUL EXISTING POST AND FOUNDATION.

| STATION: | OFFSET: | FL. ELEVATION: | CURB HEIGHT: | CURVE DESCRIPTION: | CENTER:

6.0"

0.0"

0.0"

6.0"

6.0"

0.0"

0.0"

0.5"

6.0"

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CONSULTING ENGINEERS
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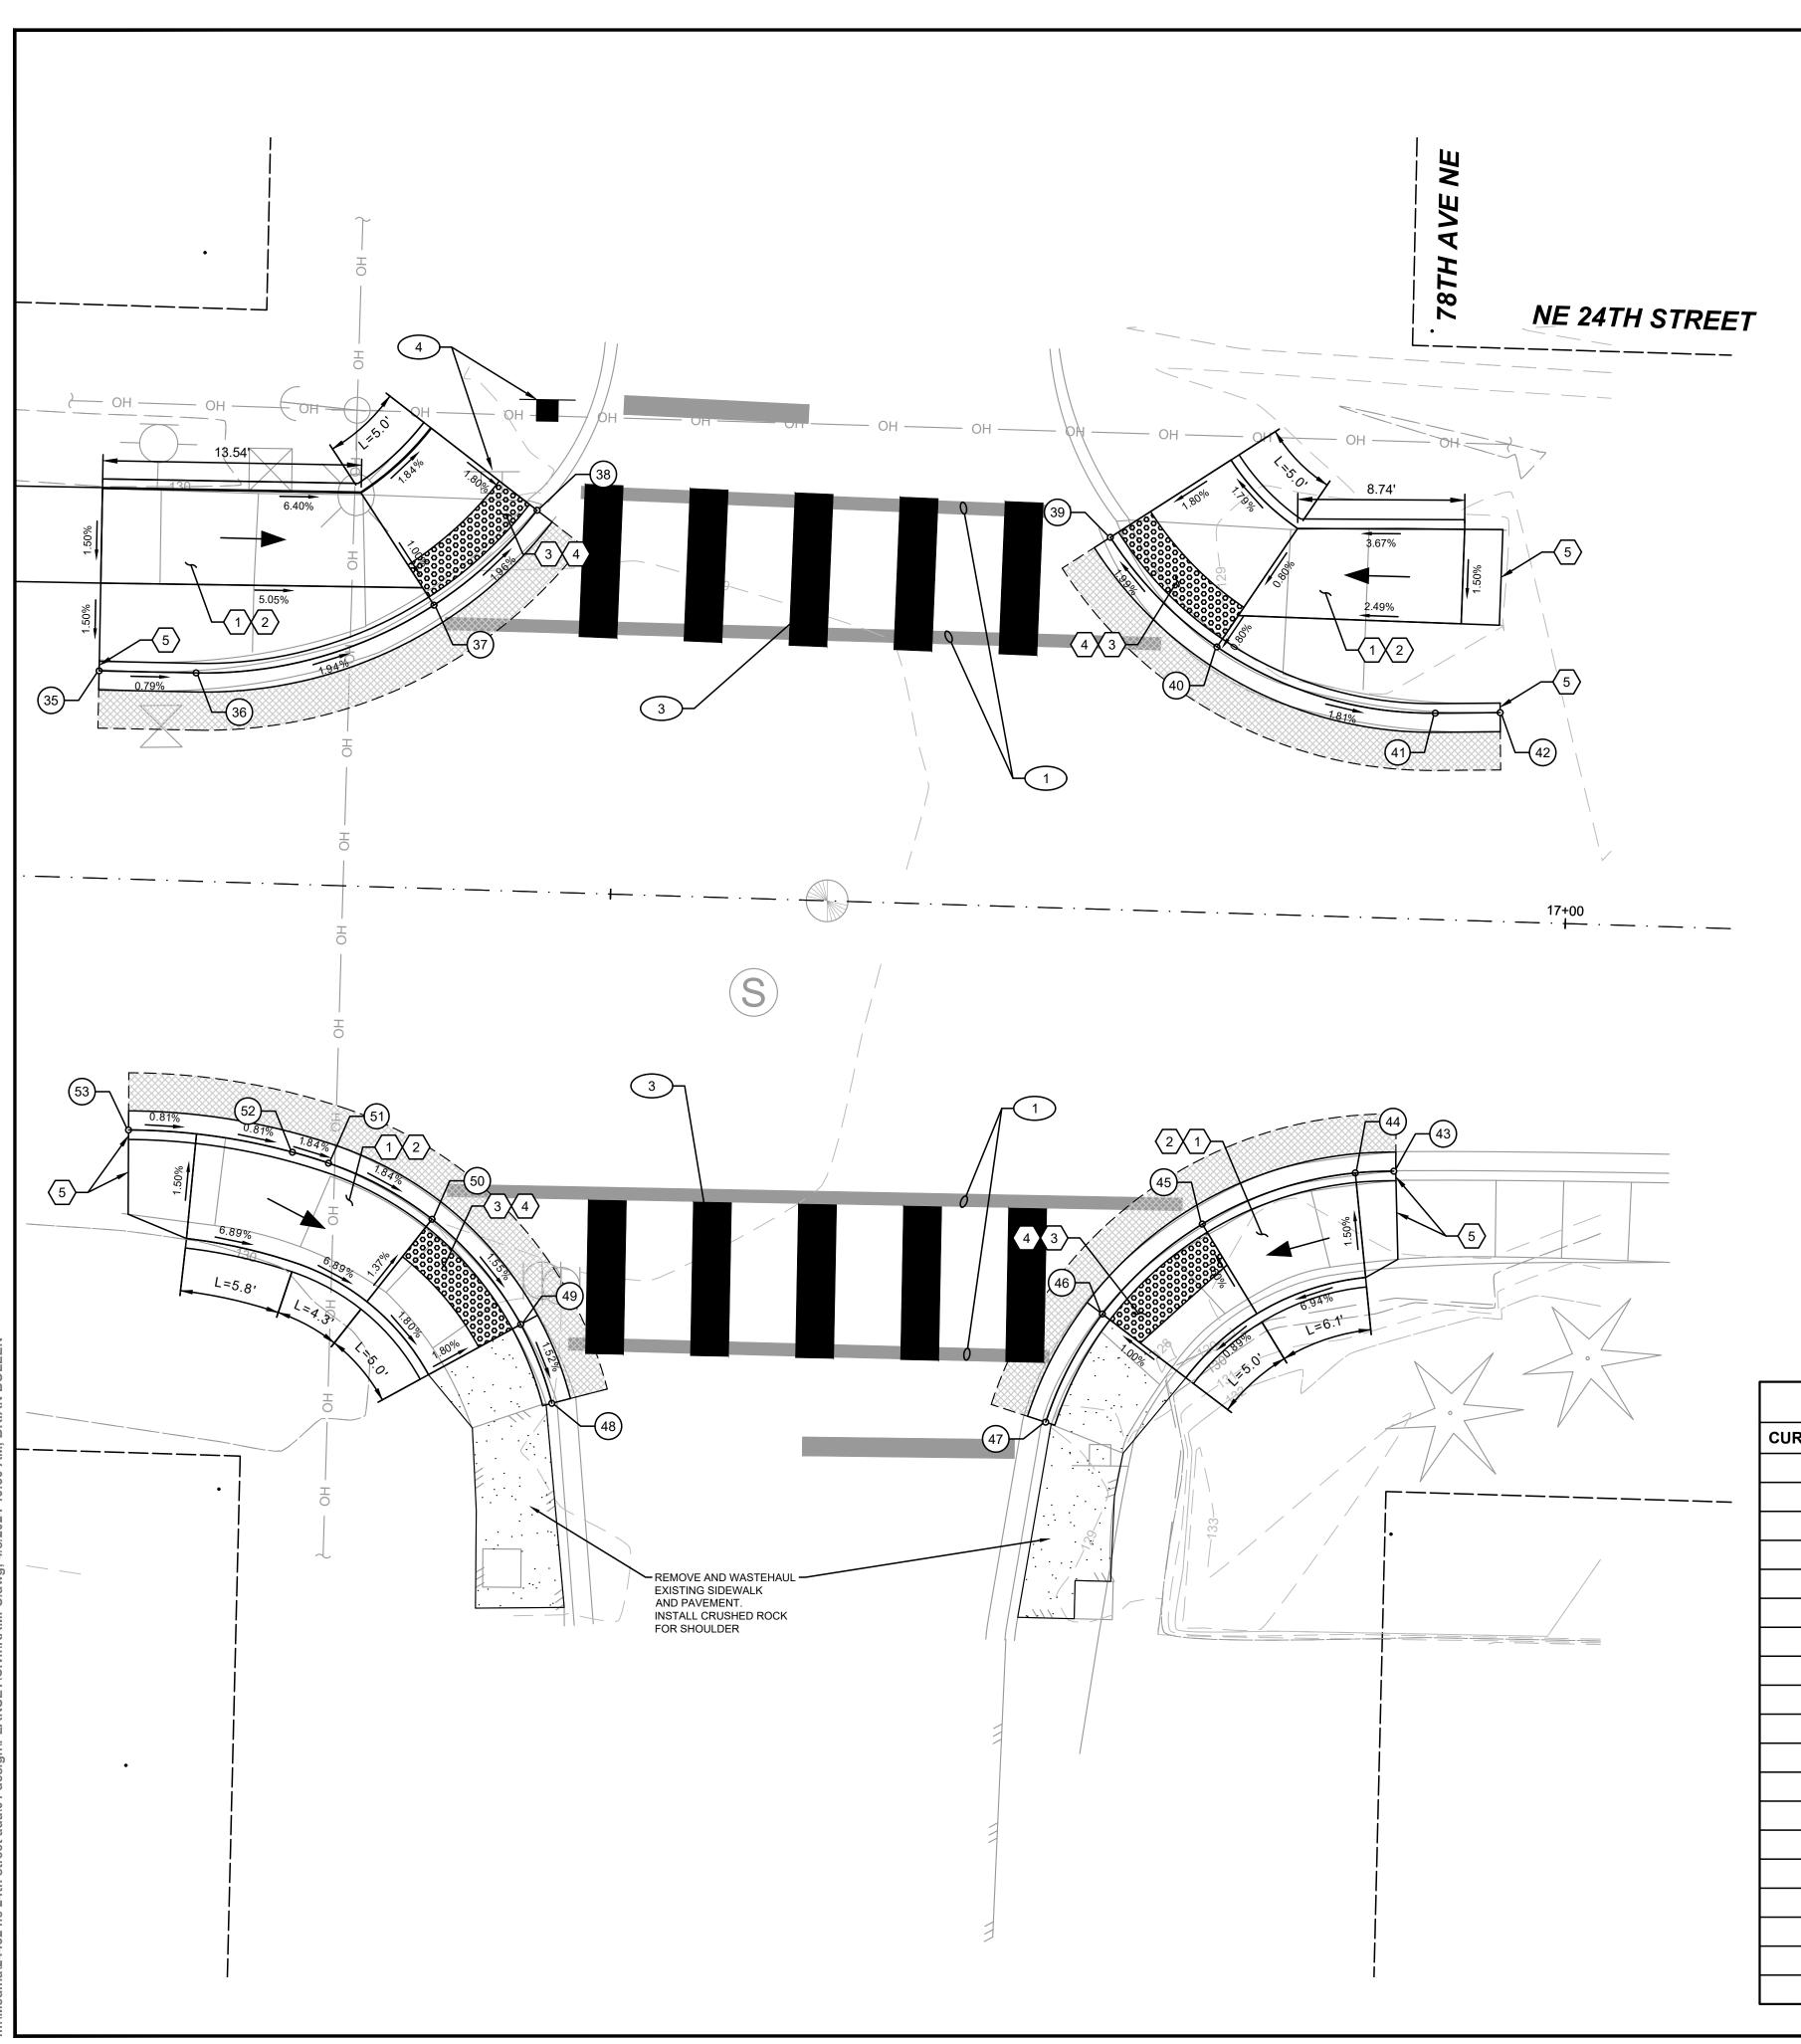
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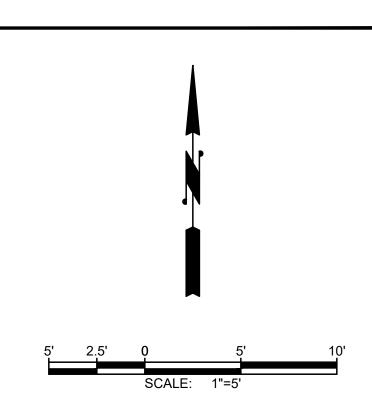
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CHECKED B	Y: BLS
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DESIGNER:	MAN
G & O JOB N	O.: 24432.00
FILE:	RAMPS.DWG

)	1	"	2'	•
TWO INC	CHES A	AT FULL	SCALE.	
IF NOT, S	SCALE	ACCOR	DINGLY	,

CURB RAMP PLANS (SCHEDULE A)

OF: **29** SHEET: 6





- 1. PAVEMENT REPAIR PER TYPICAL ROADWAY CROSS SECTION AND DETAILS, SHEETS 21.
- 2. CURB TYPE AS INDICATED ON THE PLAN. SEE DETAILS, SHEET 22.
- 3. SEE CEMENT CONCRETE SIDEWALK AND JOINTS DETAIL, SHEET 22.
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- 3. LANDING. CROSS SLOPES SHALL NOT EXCEED 2.0%.
- 4. DETECTABLE WARNING SURFACE. 2' MIN. ALONG DIRECTION OF TRAVEL, TYP. FOR ALL APPLICATIONS.
- 5. SAWCUT EXISTING CURB AND/OR SIDEWALK TO NEAREST FULL JOINT AND PROVIDE CLEAN EDGE.


CHANNELIZATION & SIGNING NOTES

- 1. REMOVE EXISTING PAVEMENT MARKINGS/LINES.
- 2. FURNISH AND INSTALL 24" PLASTIC STOP LINE PER DETAIL SHEET 27.
- 3. FURNISH AND INSTALL 8'-0" PLASTIC CROSSWALK LINE PER DETAIL SHEET 27.
- 4. RELOCATE EXISTING SIGNS. FURNISH AND INSTALL NEW HARDWARE AND POST TYPE ST-2 PER DETAIL SHEET 26. WASTEHAUL EXISTING POST AND FOUNDATION.

CURB RAMPS 5 - 8							
CURB POINT:	POINT DESCRIPTION:	STATION:	OFFSET:	FL. ELEVATION:	CURB HEIGHT:	CURVE DESCRIPTION:	CENTER:
35	MATCH EXISTING	16+22.88	10.85' LT	129.30	6.0"		
36	PC	16+27.96	10.90' LT	129.26	6.0"	L=20.51'	16+27.74
37	LANDING	16+40.29	14.83' LT	129.00	0.0"	R=22.00' Δ=53° 24' 23"	-32.90 LT
38	LANDING	16+45.53	19.96' LT	128.86	0.0"		
39	LANDING / MATCH EXISTING	16+75.58	19.47' LT	128.59	0.0"	L = 20, 48!	
40	LANDING / HIGH POINT	16+81.33	13.91' LT	128.75	0.0"	L=20.18' R=20.00'	16+92.07 -30.78 LT
41	PT	16+92.86	10.80' LT	128.53	6.0"	Δ=57° 48' 43"	00.70 21
42	MATCH EXISTING	16+96.25	10.93' LT	128.42	6.0"		
43	PT / MATCH EXISTING	16+91.43	13.23' RT	128.50	6.0"		
44	RAMP TOP	16+89.41	13.38' RT	128.55	6.0"	L=22.01'	
45	LANDING / HIGH POINT	16+81.49	16.31' RT	128.63	0.0"	R=19.00' Δ=66° 23' 02"	16+91.86 32.22 RT
46	LANDING	16+76.41	21.17' RT	128.61	0.0"	Δ-00 23 02	
47	MATCH EXISTING	16+73.62	26.92' RT	128.51	6.0"		
48	MATCH EXISTING	16+47.75	26.73' RT	128.83	6.0"	L=17.84'	
49	LANDING	16+46.00	22.66' RT	128.90	0.0"	R=18.00' Δ=56° 47' 12"	16+30.47 31.76 RT
50	LANDING	16+41.19	17.30' RT	129.01	0.0"	Δ-30 47 12	
51	PCC	16+35.68	14.53' RT	129.12	5.0"	L=10.65'	
52	RAMP TOP	16+33.78	14.02' RT	129.16	6.0"	R=33.89' Δ=18° 00' 23"	16+26.06 46.37 RT
53	MATCH EXISTING	16+25.17	13.12' RT	129.23	6.0"	Δ-10 00 23	




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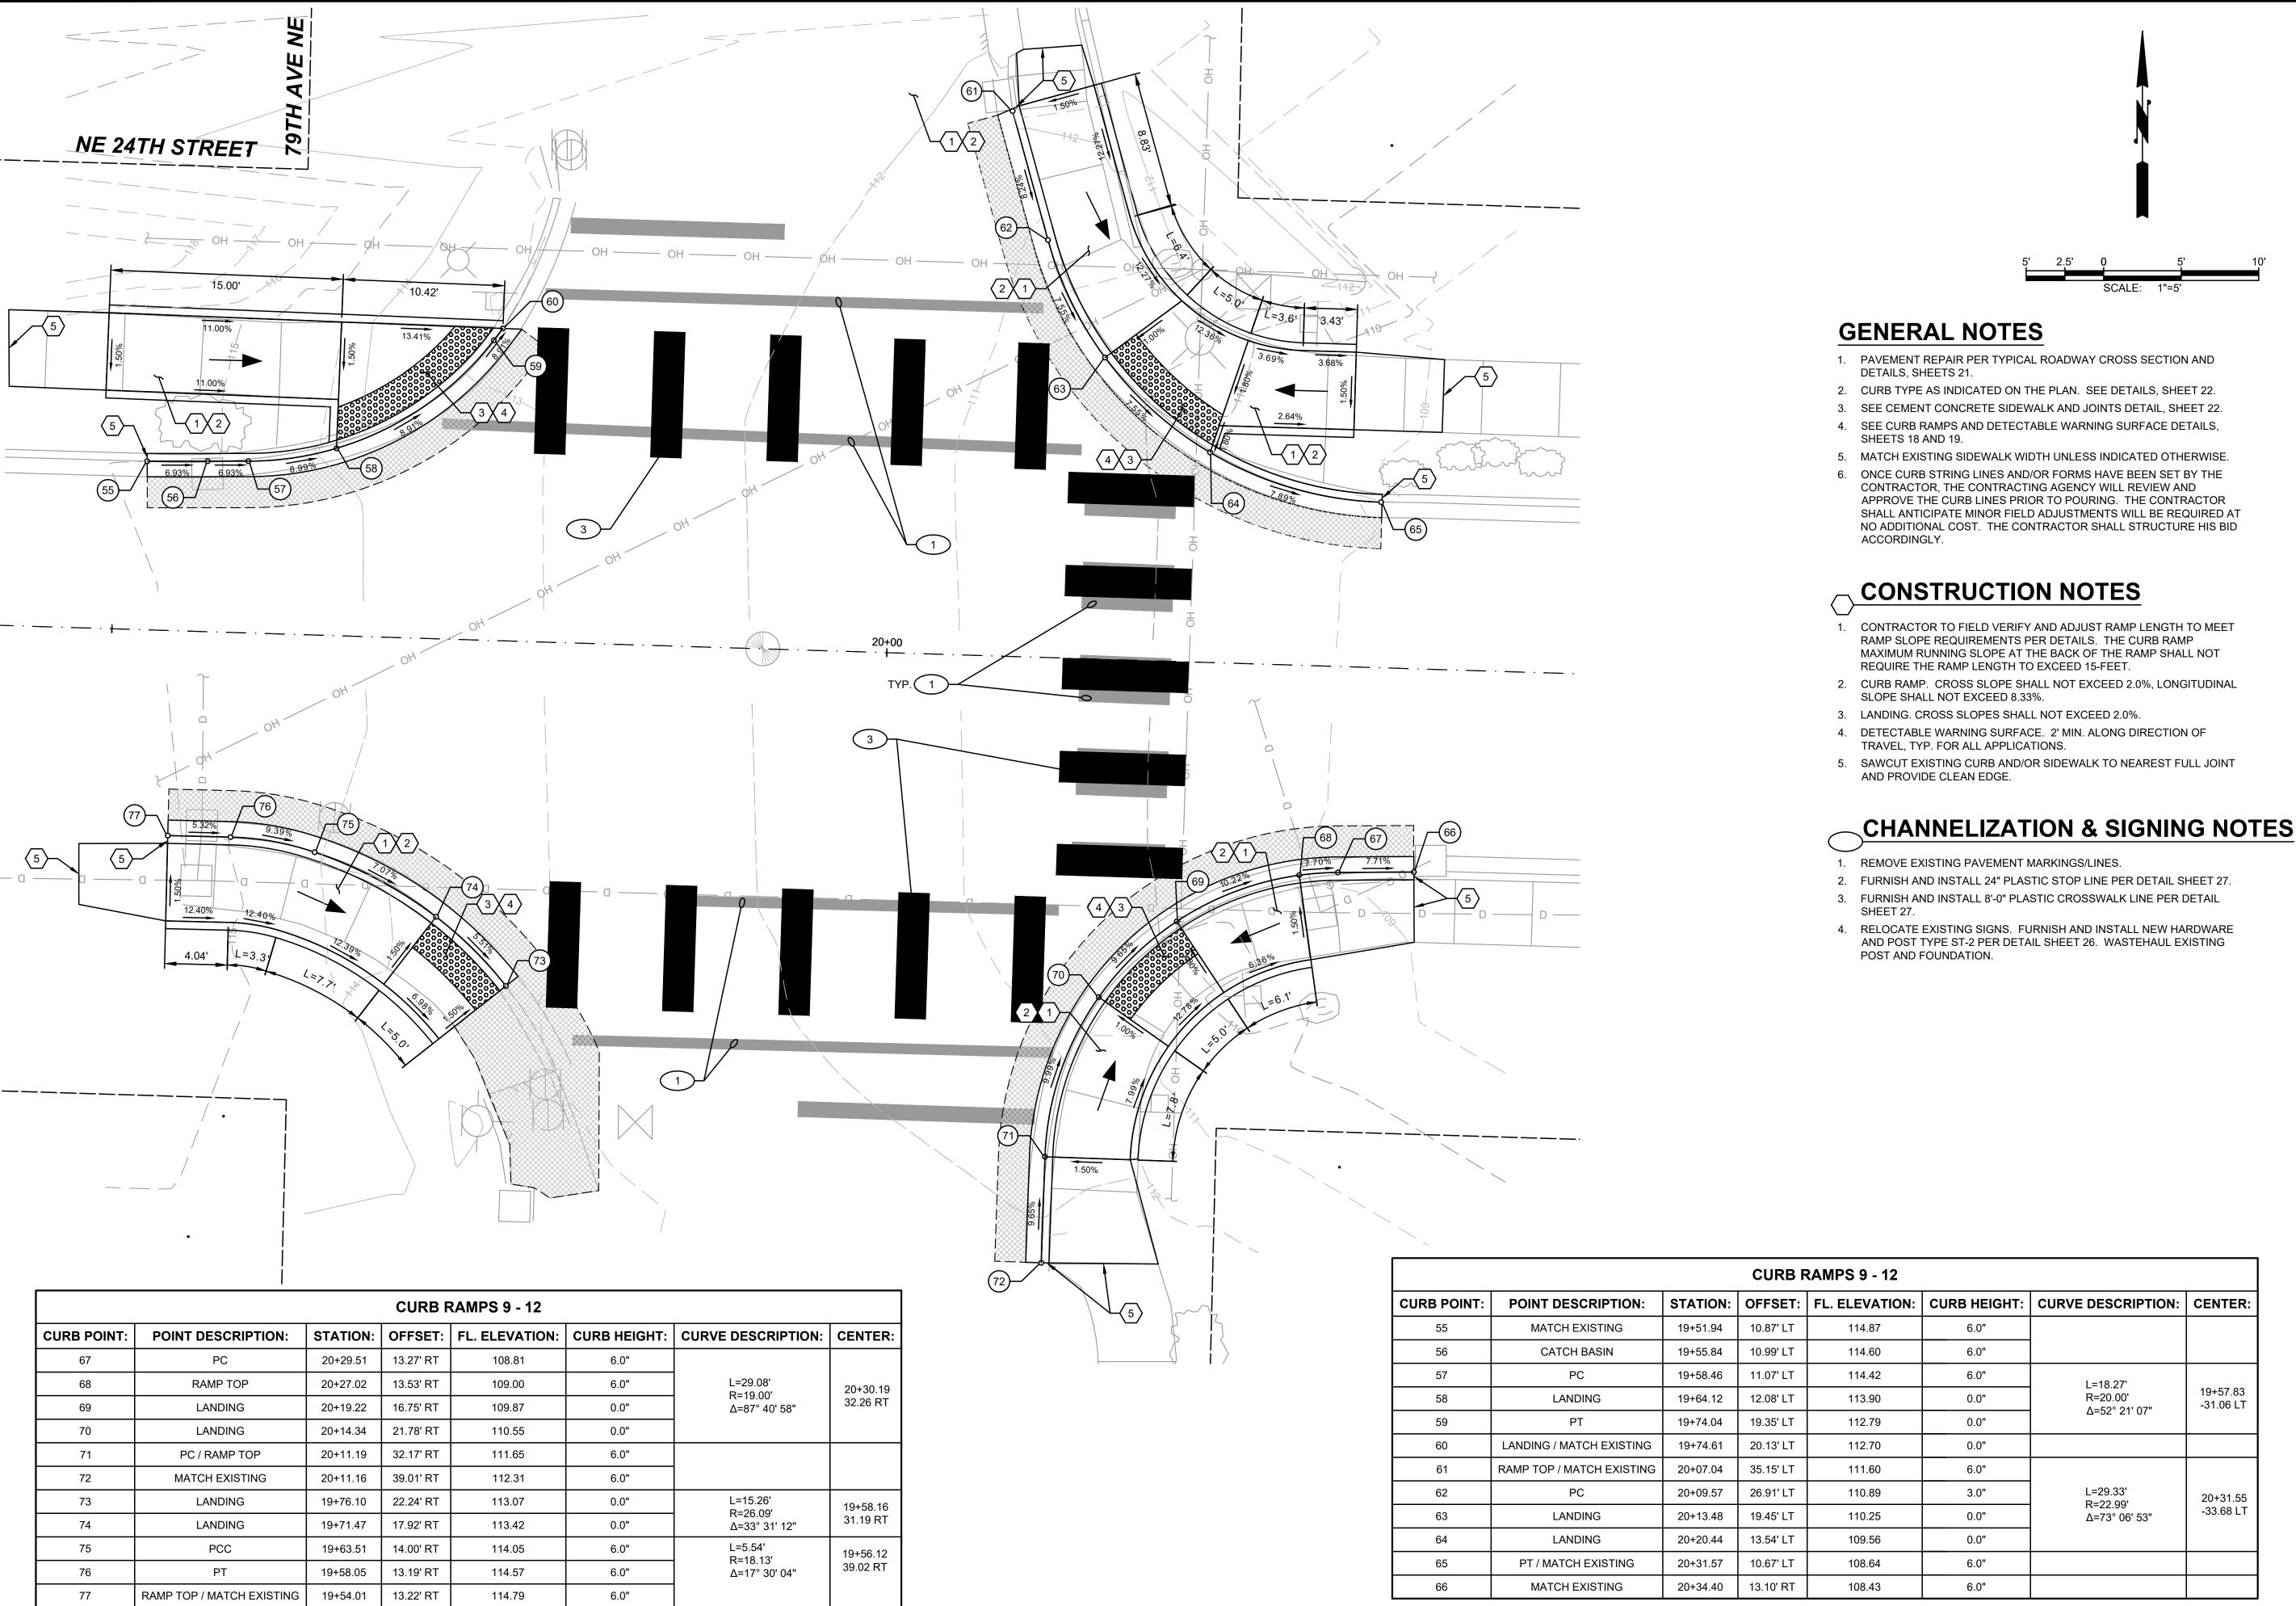
BID SET

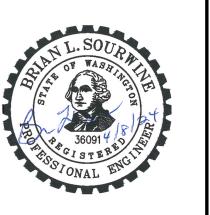ISSUE DATE: APR 2024 APPROVED BY: BLS CHECKED BY: BLS PGM DRAWN BY: DESIGNER: MAN G & O JOB NO.: 24432.00 RAMPS.DWG

TWO INCHES AT FULL SCALE IF NOT, SCALE ACCORDINGLY

CURB RAMP PLANS (SCHEDULE A)

SHEET: 7

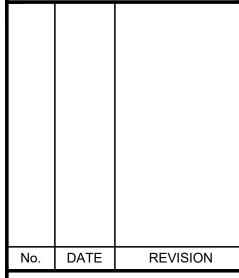



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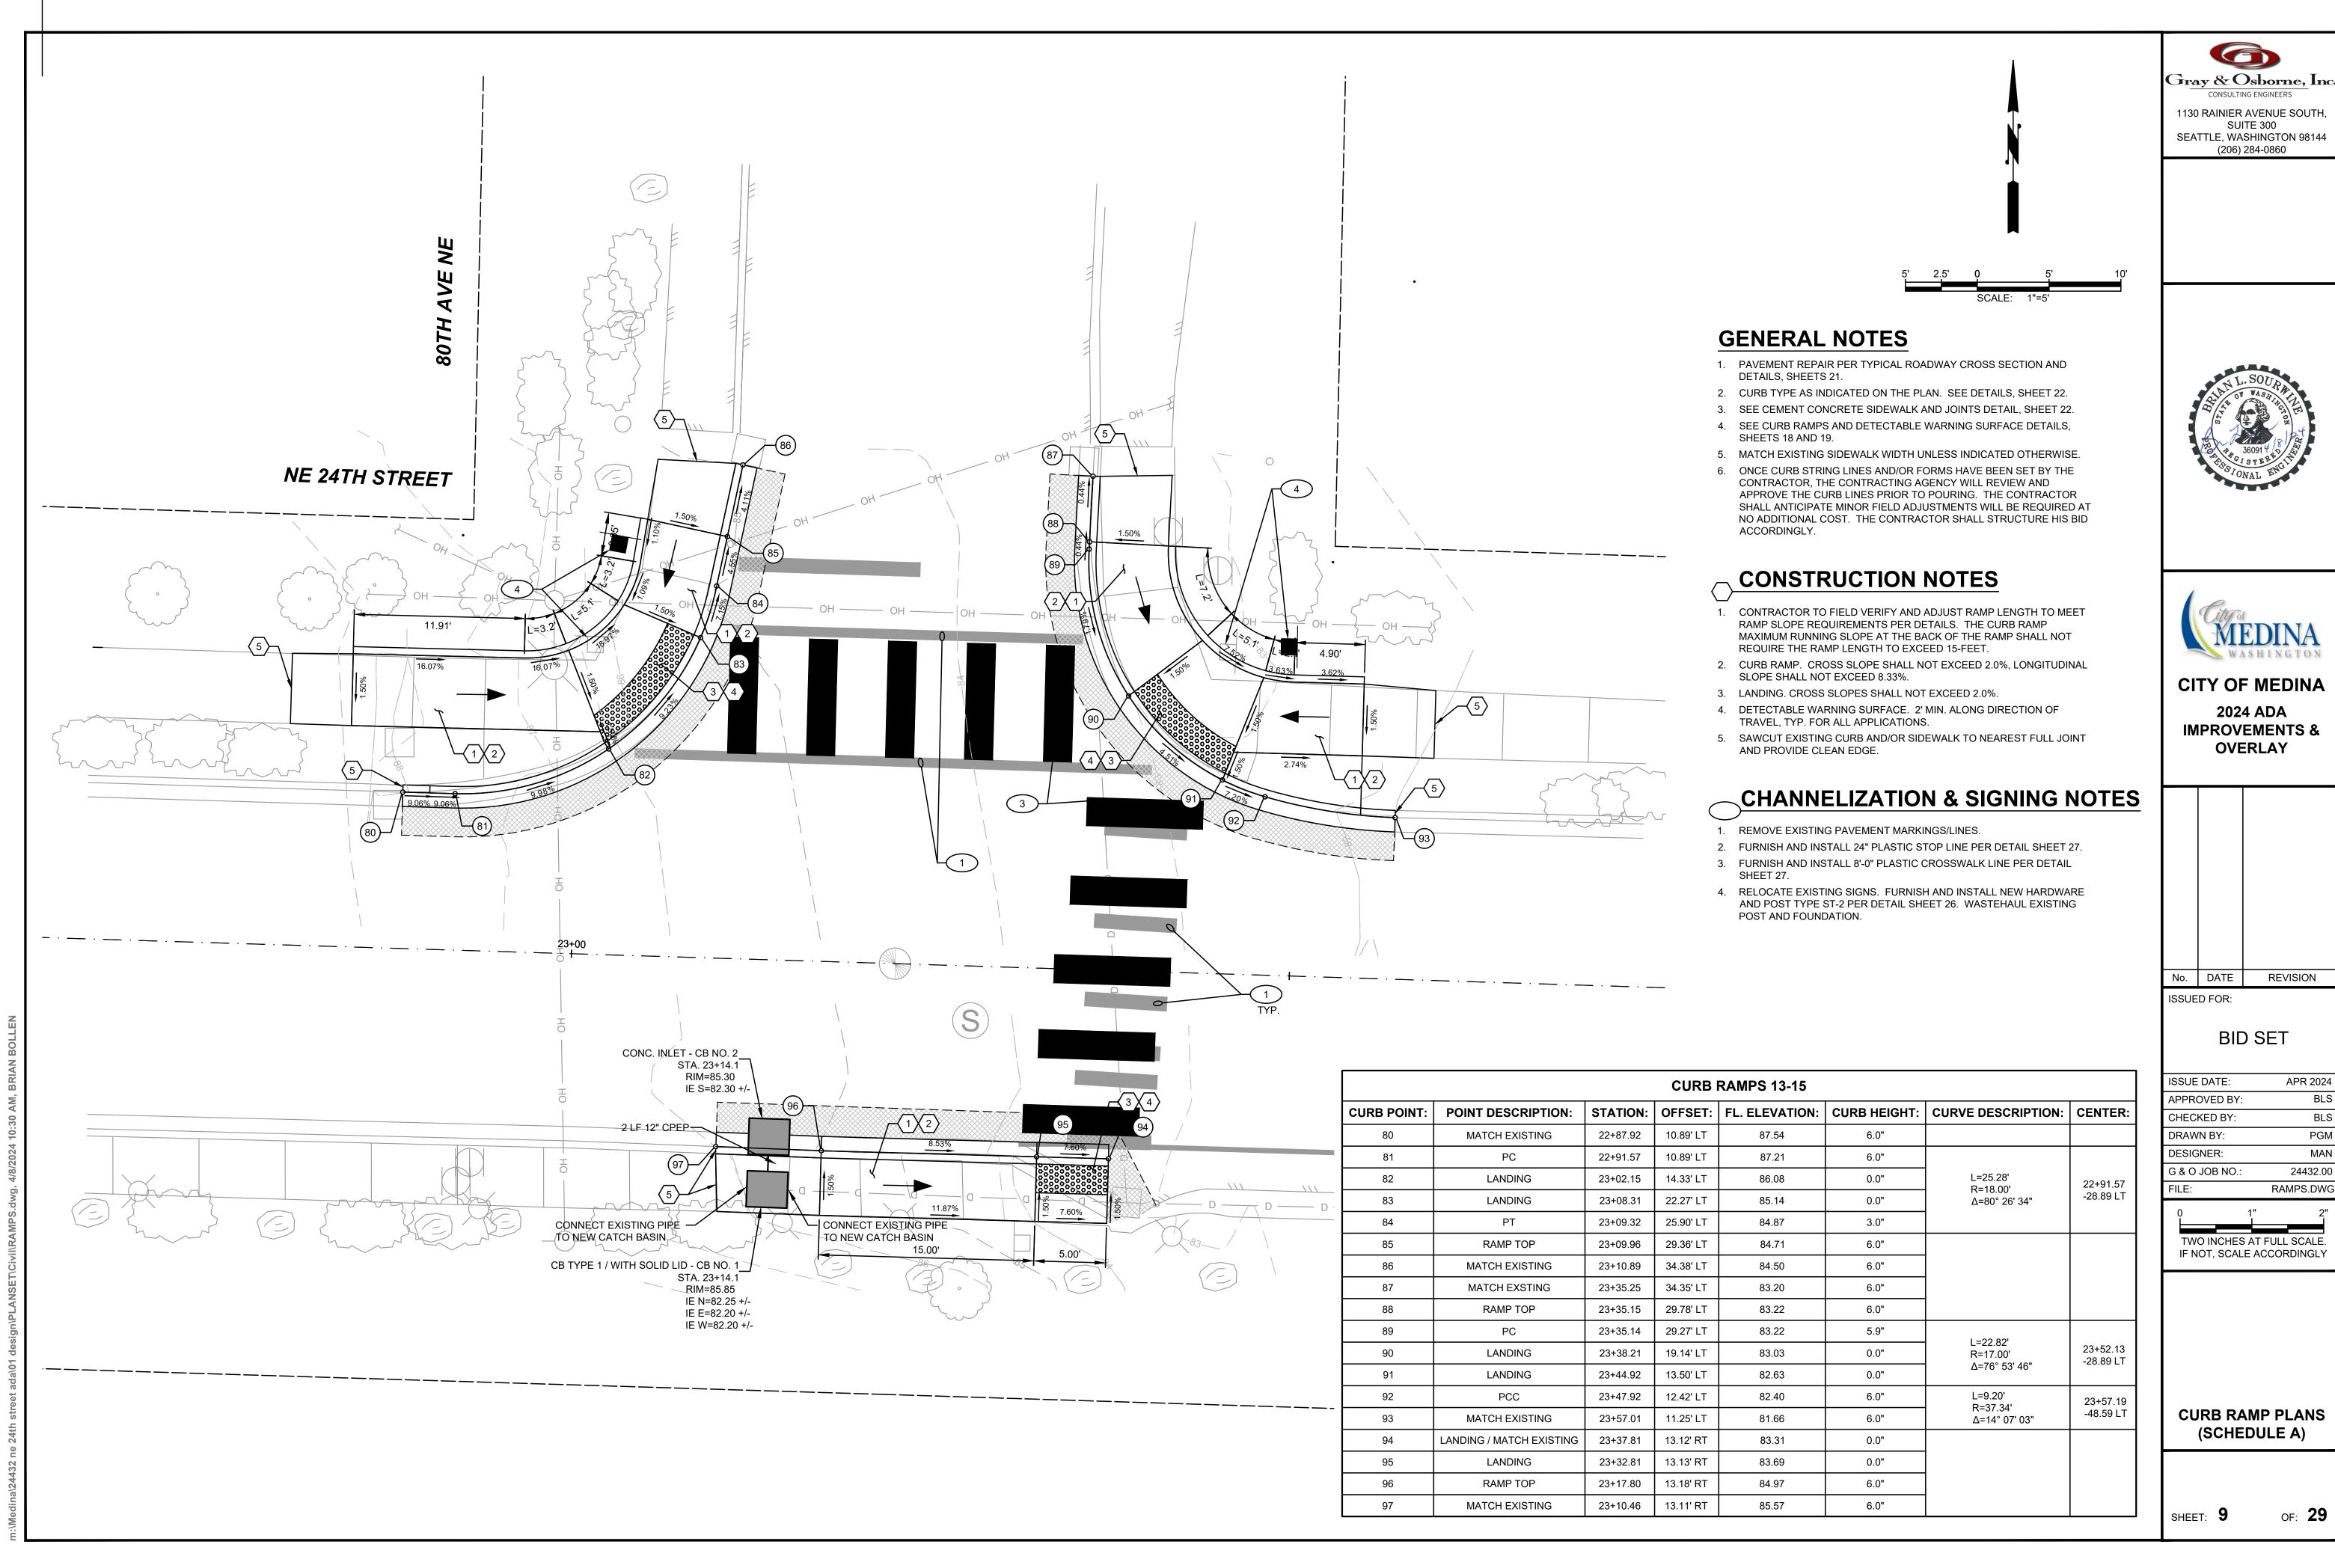
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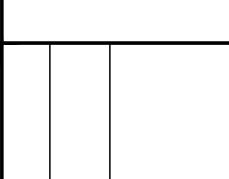
TWO INCHES AT FULL SCALE IF NOT, SCALE ACCORDINGLY

CURB RAMP PLANS (SCHEDULE A)


SHEET: 8



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CURB RAMPS 16 & 17							
CURB POINT:	POINT DESCRIPTION:	STATION:	OFFSET:	FL. ELEVATION:	CURB HEIGHT:	CURVE DESCRIPTION:	CENTER:
100	MATCH EXISTING	27+88.57	10.86' LT	51.97	6.0"		
101	LANDING	27+99.01	11.17' LT	51.62	0.0"		
102	PC / CATCH BASIN	28+00.15	11.21' LT	51.58	0.0"		
104	PT	28+13.36	20.00' LT	51.20	0.0"	L=13.63'	27+99.81
105	LANDING	28+13.65	20.64' LT	51.18	0.0"	R=14.00' Δ=55° 46' 27"	-25.29 LT
106	LANDING / MATCH EXISTING	28+44.44	20.38' LT	50.85	0.0"		
107	PCC	28+53.54	13.25' LT	50.81	0.0"	L=11.60'	28+61.57
108	LANDING	28+56.05	12.00' LT	50.80	0.0"	R=39.79' Δ=16° 42' 08"	-25.95 LT
109	PT	28+61.23	10.95' LT	50.74	6.0"	L=8.13'	28+73.28
110	MATCH EXISTING	28+66.75	10.83' LT	50.67	0.0"	R=15.15' Δ=30° 44' 02"	-47.79 LT



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DESIGNER:	MAN
G & O JOB NO.:	24432.00
FILE:	RAMPS.DWG

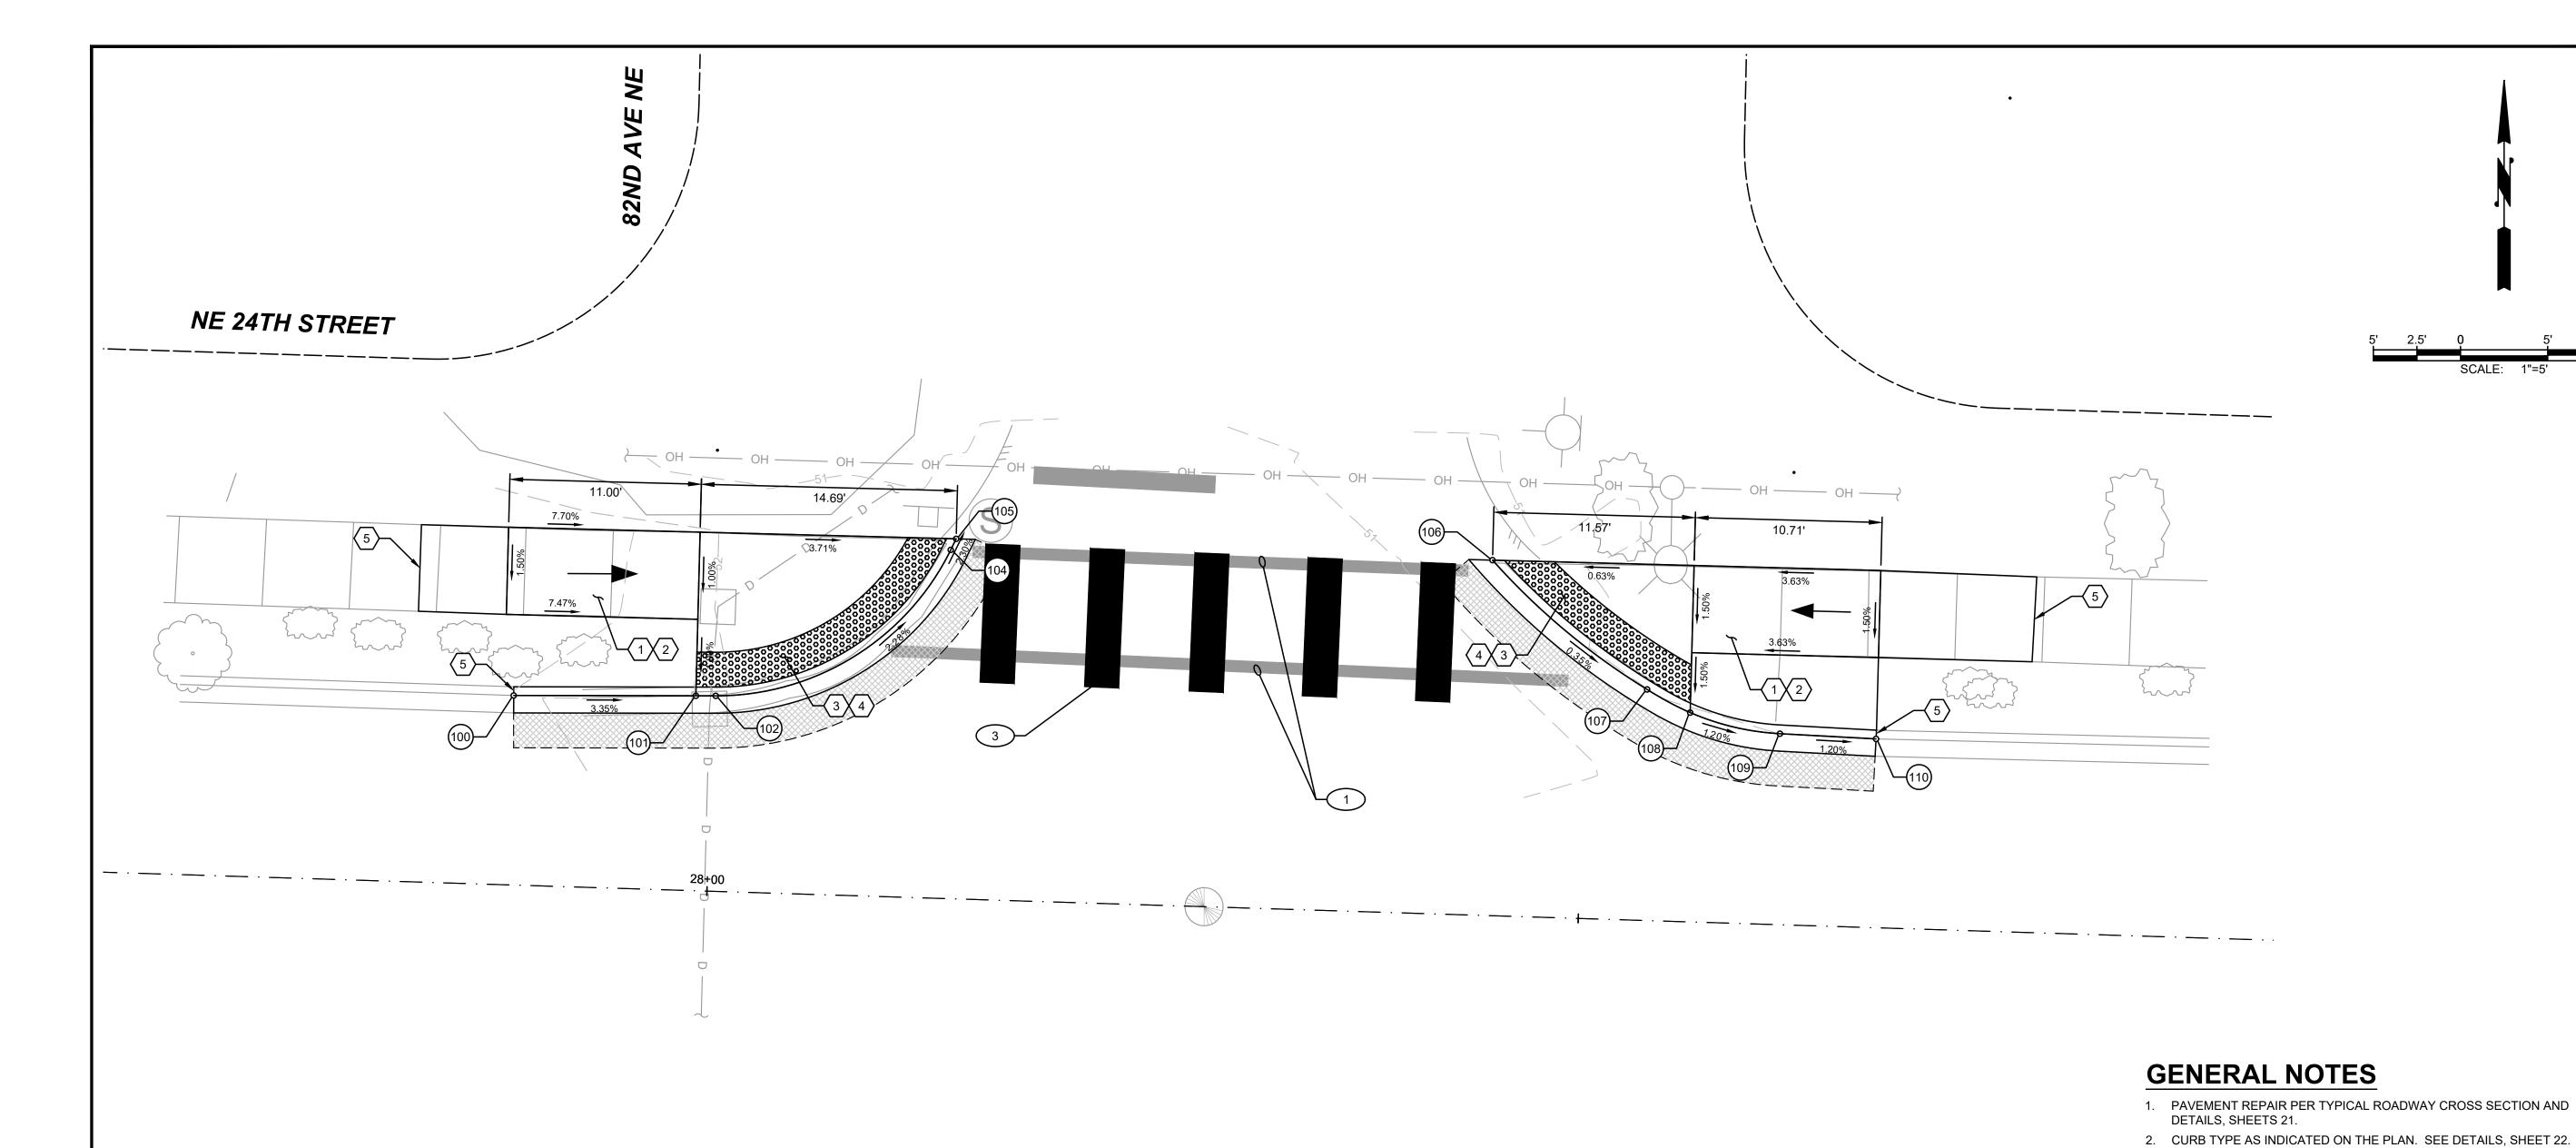TWO INCHES AT FULL SCALE.
IF NOT, SCALE ACCORDINGLY

CHANNELIZATION & SIGNING NOTES

1. REMOVE EXISTING PAVEMENT MARKINGS/LINES.

SLOPE SHALL NOT EXCEED 8.33%.

AND PROVIDE CLEAN EDGE.

TRAVEL, TYP. FOR ALL APPLICATIONS.

2. FURNISH AND INSTALL 24" PLASTIC STOP LINE PER DETAIL SHEET 27.

SEE CEMENT CONCRETE SIDEWALK AND JOINTS DETAIL, SHEET 22.
 SEE CURB RAMPS AND DETECTABLE WARNING SURFACE DETAILS,

5. MATCH EXISTING SIDEWALK WIDTH UNLESS INDICATED OTHERWISE.

6. ONCE CURB STRING LINES AND/OR FORMS HAVE BEEN SET BY THE CONTRACTOR, THE CONTRACTING AGENCY WILL REVIEW AND APPROVE THE CURB LINES PRIOR TO POURING. THE CONTRACTOR

 CONTRACTOR TO FIELD VERIFY AND ADJUST RAMP LENGTH TO MEET RAMP SLOPE REQUIREMENTS PER DETAILS. THE CURB RAMP MAXIMUM RUNNING SLOPE AT THE BACK OF THE RAMP SHALL NOT

2. CURB RAMP. CROSS SLOPE SHALL NOT EXCEED 2.0%, LONGITUDINAL

5. SAWCUT EXISTING CURB AND/OR SIDEWALK TO NEAREST FULL JOINT

4. DETECTABLE WARNING SURFACE. 2' MIN. ALONG DIRECTION OF

CONSTRUCTION NOTES

REQUIRE THE RAMP LENGTH TO EXCEED 15-FEET.

3. LANDING. CROSS SLOPES SHALL NOT EXCEED 2.0%.

SHALL ANTICIPATE MINOR FIELD ADJUSTMENTS WILL BE REQUIRED AT NO ADDITIONAL COST. THE CONTRACTOR SHALL STRUCTURE HIS BID


SHEETS 18 AND 19.

ACCORDINGLY.


- 3. FURNISH AND INSTALL 8'-0" PLASTIC CROSSWALK LINE PER DETAIL SHEET 27.
- 4. RELOCATE EXISTING SIGNS. FURNISH AND INSTALL NEW HARDWARE AND POST TYPE ST-2 PER DETAIL SHEET 26. WASTEHAUL EXISTING POST AND FOUNDATION.

CURB RAMP PLANS (SCHEDULE A)

SHEET: 10 OF: 29

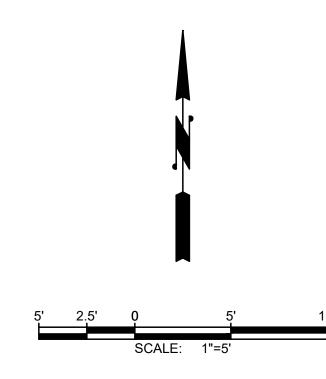



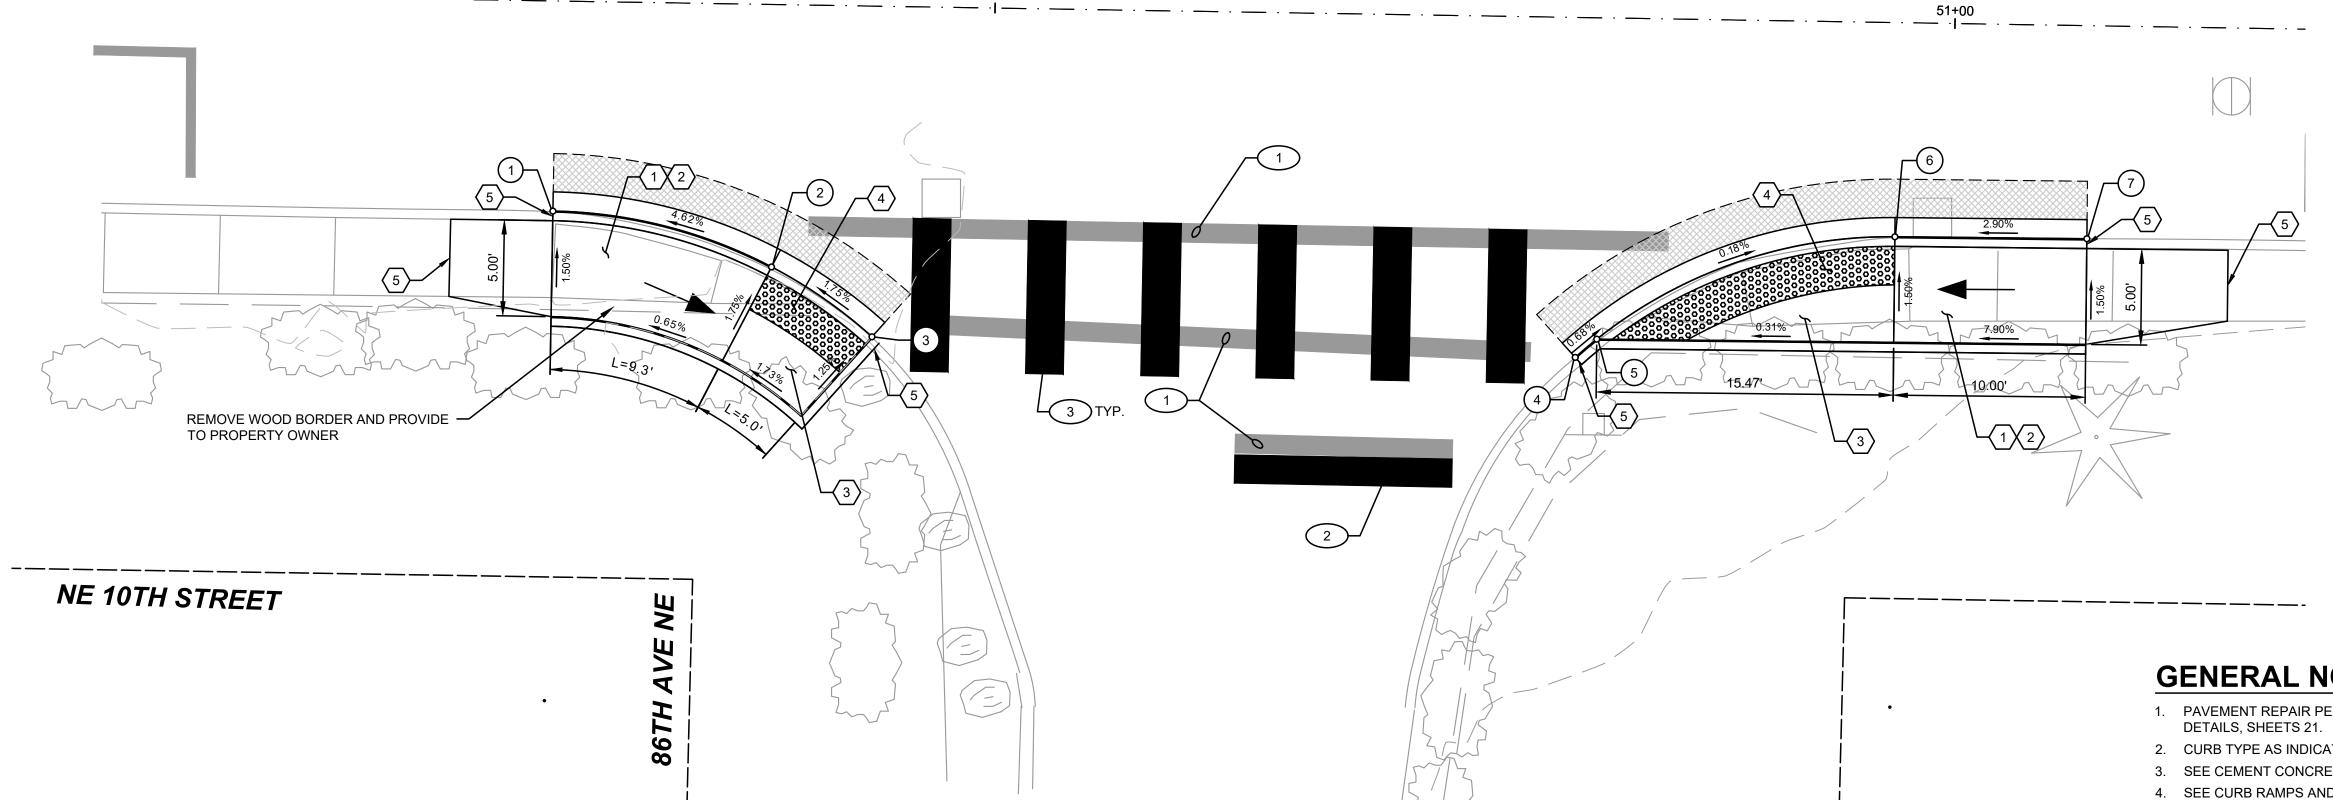

	CURB RAMPS 1 & 2							
CURB POINT:	CURB POINT: POINT DESCRIPTION: STATION: OFFSET: FL. ELEVATION: CURB HEIGHT: CURVE DESCRIPTION: CEN							
1	PC / TOP RAMP/ MATCH EXISTING	50+27.14	10.94' RT	107.25	6.0"			
2	LANDING	50+38.57	13.67' RT	107.80	0.0"	L=18.25', R=25.50' Δ=41°00'01"	50+27.11 36.44 RT	
3	LANDING / MATCH EXISTING	50+43.86	17.22' RT	107.91	0.0" / 6.0"			
4	PC / MATCH EXISTING	50+80.50	17.71' RT	108.71	6.0"			
5	LANDING	50+81.61	16.74' RT	108.70	0.0" / 6.0"	L=18.21', R=24.50' Δ=42°35'14"	50+97.18 35.65 RT	
6	PT / LANDING	50+97.05	11.16' RT	108.67	0.0"			
7	TOP RAMP / MATCH EXISTING	51+07.05	11.10' RT	108.96	6.0"			



- 1. PAVEMENT REPAIR PER TYPICAL ROADWAY CROSS SECTION AND
- 2. CURB TYPE AS INDICATED ON THE PLAN. SEE DETAILS, SHEET 22.
- 3. SEE CEMENT CONCRETE SIDEWALK AND JOINTS DETAIL, SHEET 22.
- 4. SEE CURB RAMPS AND DETECTABLE WARNING SURFACE DETAILS, SHEETS 18 AND 19.
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CONSTRUCTION NOTES

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- 3. LANDING. CROSS SLOPES SHALL NOT EXCEED 2.0%.
- 4. DETECTABLE WARNING SURFACE. 2' MIN. ALONG DIRECTION OF TRAVEL, TYP. FOR ALL APPLICATIONS.
- 5. SAWCUT EXISTING CURB AND/OR SIDEWALK TO NEAREST FULL JOINT AND PROVIDE CLEAN EDGE.


CHANNELIZATION & SIGNING NOTES

- 1. REMOVE EXISTING PAVEMENT MARKINGS/LINES.
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- 3. FURNISH AND INSTALL 8'-0" PLASTIC CROSSWALK LINE PER DETAIL
- 4. RELOCATE EXISTING SIGNS. FURNISH AND INSTALL NEW HARDWARE AND POST TYPE ST-2 PER DETAIL SHEET 26. WASTEHAUL EXISTING POST AND FOUNDATION.



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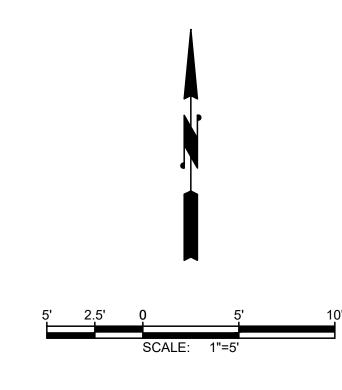
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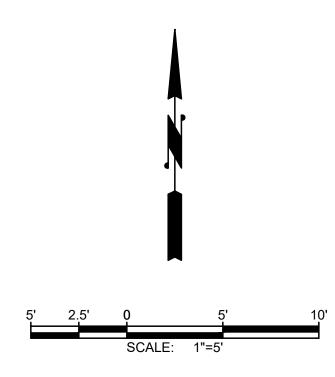
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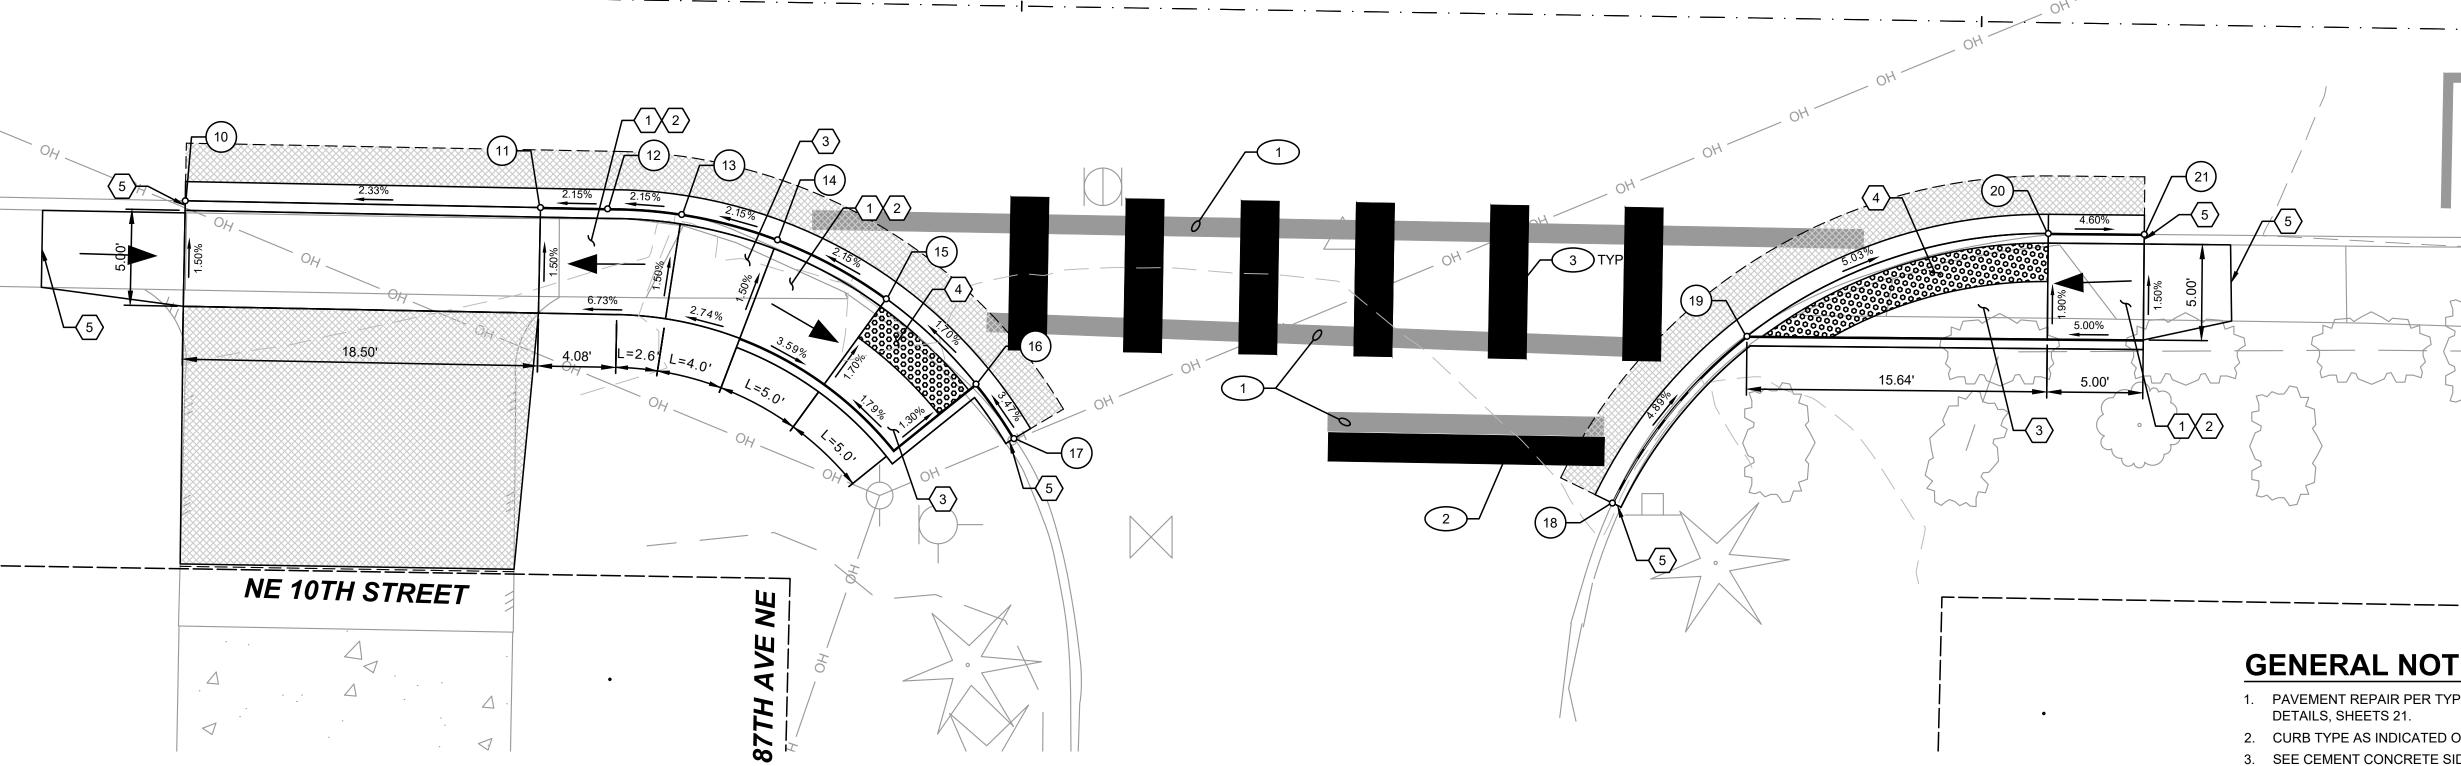
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CURB RAMP PLANS (SCHEDULE B)

SHEET: **11**

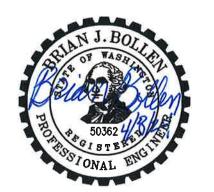





	CURB RAMPS 3 & 4							
CURB POINT:	POINT DESCRIPTION:	STATION:	OFFSET:	FL. ELEVATION:	CURB HEIGHT:	CURVE DESCRIPTION:	CENTER:	
10	BEGIN DRIVEWAY / MATCH EXISTING	53+56.60	10.84' RT	121.10	0.5"			
11	END DRIVEWAY / BOTTOM RAMP	53+75.11	10.89' RT	121.53	0.5"			
12	PC	53+78.60	10.90' RT	121.61	2.0"			
13	TOP RAMP	53+82.46	11.13' RT	121.69	4.0"			
14	TOP RAMP	53+87.47	12.37' RT	121.80	4.0"	L=25.44', R=24.52'	53+79.11	
15	LANDING / BOTTOM RAMP	53+93.19	15.35' RT	121.94	0.0"	Δ=59°25'34"	35.40 RT	
16	LANDING	53+97.93	19.72' RT	122.05	0.0" / 6.0"			
17	MATCH EXISTING	53+99.95	22.52' RT	122.17	6.0"			
18	MATCH EXISTING	54+31.17	25.38' RT	121.89	0.0"			
19	LANDING	54+38.04	16.58' RT	121.34	0.0" / 6.0"	L=28.16', R=25.00' Δ=64°31'42"	54+53.82 35.98 RT	
20	PT / LANDING / BOTTOM RAMP	54+53.65	10.98' RT	120.49	0.0"			
21	TOP RAMP / MATCH EXISTING	54+58.65	10.94' RT	120.26	6.0"			

- 1. PAVEMENT REPAIR PER TYPICAL ROADWAY CROSS SECTION AND
- 2. CURB TYPE AS INDICATED ON THE PLAN. SEE DETAILS, SHEET 22. 3. SEE CEMENT CONCRETE SIDEWALK AND JOINTS DETAIL, SHEET 22.
- 4. SEE CURB RAMPS AND DETECTABLE WARNING SURFACE DETAILS,
- SHEETS 18 AND 19. 5. MATCH EXISTING SIDEWALK WIDTH UNLESS INDICATED OTHERWISE.
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- 3. LANDING. CROSS SLOPES SHALL NOT EXCEED 2.0%.
- 4. DETECTABLE WARNING SURFACE. 2' MIN. ALONG DIRECTION OF
- TRAVEL, TYP. FOR ALL APPLICATIONS.
- 5. SAWCUT EXISTING CURB AND/OR SIDEWALK TO NEAREST FULL JOINT AND PROVIDE CLEAN EDGE.

CHANNELIZATION & SIGNING NOTES

- 1. REMOVE EXISTING PAVEMENT MARKINGS/LINES.
- 2. FURNISH AND INSTALL 24" PLASTIC STOP LINE PER DETAIL SHEET 27.
- 3. FURNISH AND INSTALL 8'-0" PLASTIC CROSSWALK LINE PER DETAIL SHEET 27.
- 4. RELOCATE EXISTING SIGNS. FURNISH AND INSTALL NEW HARDWARE AND POST TYPE ST-2 PER DETAIL SHEET 26. WASTEHAUL EXISTING POST AND FOUNDATION.



1130 RAINIER AVENUE SOUTH, SUITE 300 SEATTLE, WASHINGTON 98144 (206) 284-0860








CITY OF MEDINA

2024 ADA **IMPROVEMENTS & OVERLAY**

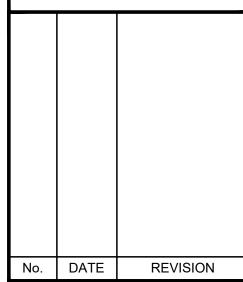

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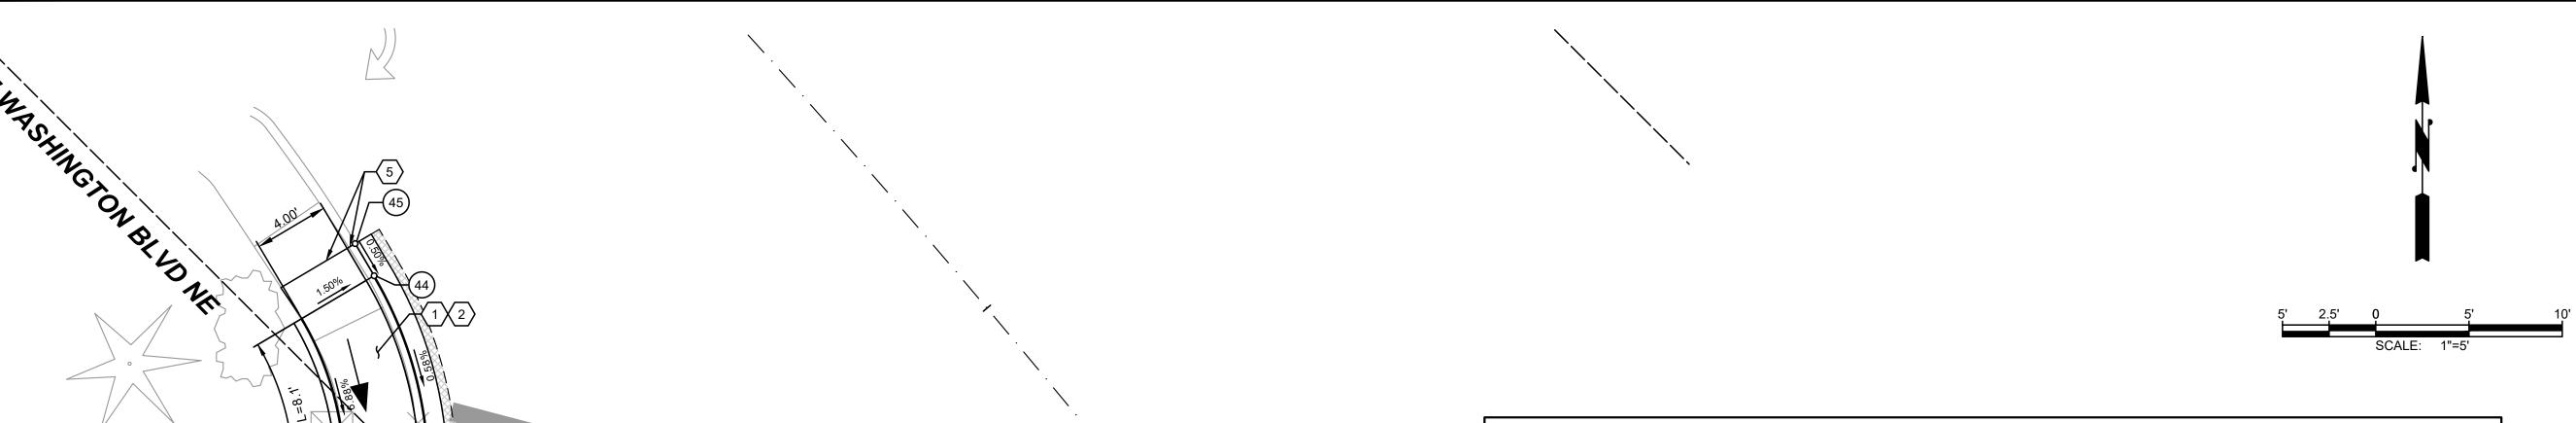
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ISSUE DATE:	APR 2024
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G & O JOB NO.:	24432.00
FILE:	RAMPS.DWG

TWO INCHES AT FULL SCALE. IF NOT, SCALE ACCORDINGLY

CURB RAMP PLANS (SCHEDULE B)

SHEET: **12**



	CURB RAMPS 7 & 8							
CURB POINT:	POINT DESCRIPTION:	STATION:	OFFSET:	FL. ELEVATION:	CURB HEIGHT:	CURVE DESCRIPTION:	CENTER:	
40	MATCH EXISTING	59+65.78	31.86' LT	94.60	6.0"			
41	PC	59+66.25	32.64' LT	94.61	6.0"			
42	LANDING	59+67.67	35.40' LT	94.66	0.0" / 6.0"	L=23.94', R=21.07'	76+21.77	
43	LANDING / RAMP BOTTOM	59+69.27	44.75' LT	94.75	0.0"	Δ=65°04'55"	44.03 RT	
44	PT / RAMP TOP	59+66.21	54.53' LT	94.81	6.0"			
45	MATCH EXISTING	59+65.16	56.23' LT	94.82	6.0"			
46	MATCH EXISTING	59+94.26	10.64' RT	94.29	6.0"			
47	RAMP LANDING	60+04.99	10.68' RT	94.06	0.0" / 6.0"			
48	PC	60+06.19	10.69' RT	94.04	0.0"			
49	RAMP LANDING	60+09.98	10.82' RT	93.96	0.0" / 6.0"	L=7.55', R=60.00' Δ=7°12'33"	77+61.55 66.84 RT	
50	MATCH EXISTING	60+13.72	11.19' RT	93.89	6.0"		20.0	

- 1. PAVEMENT REPAIR PER TYPICAL ROADWAY CROSS SECTION AND DETAILS, SHEETS 21.
- 2. CURB TYPE AS INDICATED ON THE PLAN. SEE DETAILS, SHEET 22. 3. SEE CEMENT CONCRETE SIDEWALK AND JOINTS DETAIL, SHEET 22.
- 4. SEE CURB RAMPS AND DETECTABLE WARNING SURFACE DETAILS, SHEETS 18 AND 19.
- 5. MATCH EXISTING SIDEWALK WIDTH UNLESS INDICATED OTHERWISE.
- CONTRACTOR, THE CONTRACTING AGENCY WILL REVIEW AND APPROVE THE CURB LINES PRIOR TO POURING. THE CONTRACTOR SHALL ANTICIPATE MINOR FIELD ADJUSTMENTS WILL BE REQUIRED AT NO ADDITIONAL COST. THE CONTRACTOR SHALL STRUCTURE HIS BID ACCORDINGLY.

CONSTRUCTION NOTES


- 1. CONTRACTOR TO FIELD VERIFY AND ADJUST RAMP LENGTH TO MEET RAMP SLOPE REQUIREMENTS PER DETAILS. THE CURB RAMP MAXIMUM RUNNING SLOPE AT THE BACK OF THE RAMP SHALL NOT REQUIRE THE RAMP LENGTH TO EXCEED 15-FEET.
- 2. CURB RAMP. CROSS SLOPE SHALL NOT EXCEED 2.0%, LONGITUDINAL SLOPE SHALL NOT EXCEED 8.33%.
- 3. LANDING. CROSS SLOPES SHALL NOT EXCEED 2.0%.
- 4. DETECTABLE WARNING SURFACE. 2' MIN. ALONG DIRECTION OF TRAVEL, TYP. FOR ALL APPLICATIONS.
- 5. SAWCUT EXISTING CURB AND/OR SIDEWALK TO NEAREST FULL JOINT AND PROVIDE CLEAN EDGE.

CHANNELIZATION & SIGNING NOTES

- 1. REMOVE EXISTING PAVEMENT MARKINGS/LINES.
- 2. FURNISH AND INSTALL 24" PLASTIC STOP LINE PER DETAIL SHEET 27.
- 3. FURNISH AND INSTALL 8'-0" PLASTIC CROSSWALK LINE PER DETAIL
- 4. RELOCATE EXISTING SIGNS. FURNISH AND INSTALL NEW HARDWARE AND POST TYPE ST-2 PER DETAIL SHEET 26. WASTEHAUL EXISTING POST AND FOUNDATION.

TRAFFIC SIGNAL NOTES

- 1. REMOVE AND WASTEHAUL EXISTING JUNCTION BOX. FURNISH AND INSTALL TYPE 1 JUNCTION BOX TO NEW FINISHED GRADE.
- 2. REMOVE AND WASTEHAUL EXISTING TRAFFIC SIGNAL JUNCTION BOX. FURNISH AND INSTALL NEW TYPE 8 JUNCTION BOX BEHIND NEW SIDEWALK. EXTEND EXISTING CONDUITS TO NEW JUNCTION BOX. NO NEW CABLES REQUIRED. COORDINATE WITH CITY OF BELLEVUE SIGNAL DEPARTMENT.
- 3. REMOVE AND REINSTALL EXISTING PEDESTRIAN PUSH BUTTON ASSEMBLE TO OPPOSITE SIDE OF POLE AND FURNISH AND INSTALL NEW PUSH BUTTON SIGN. PLUG HOLES.

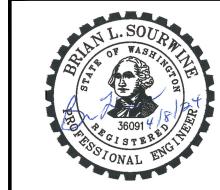

Gray & Osborne, Inc.


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CITY OF MEDINA

2024 ADA **IMPROVEMENTS & OVERLAY**



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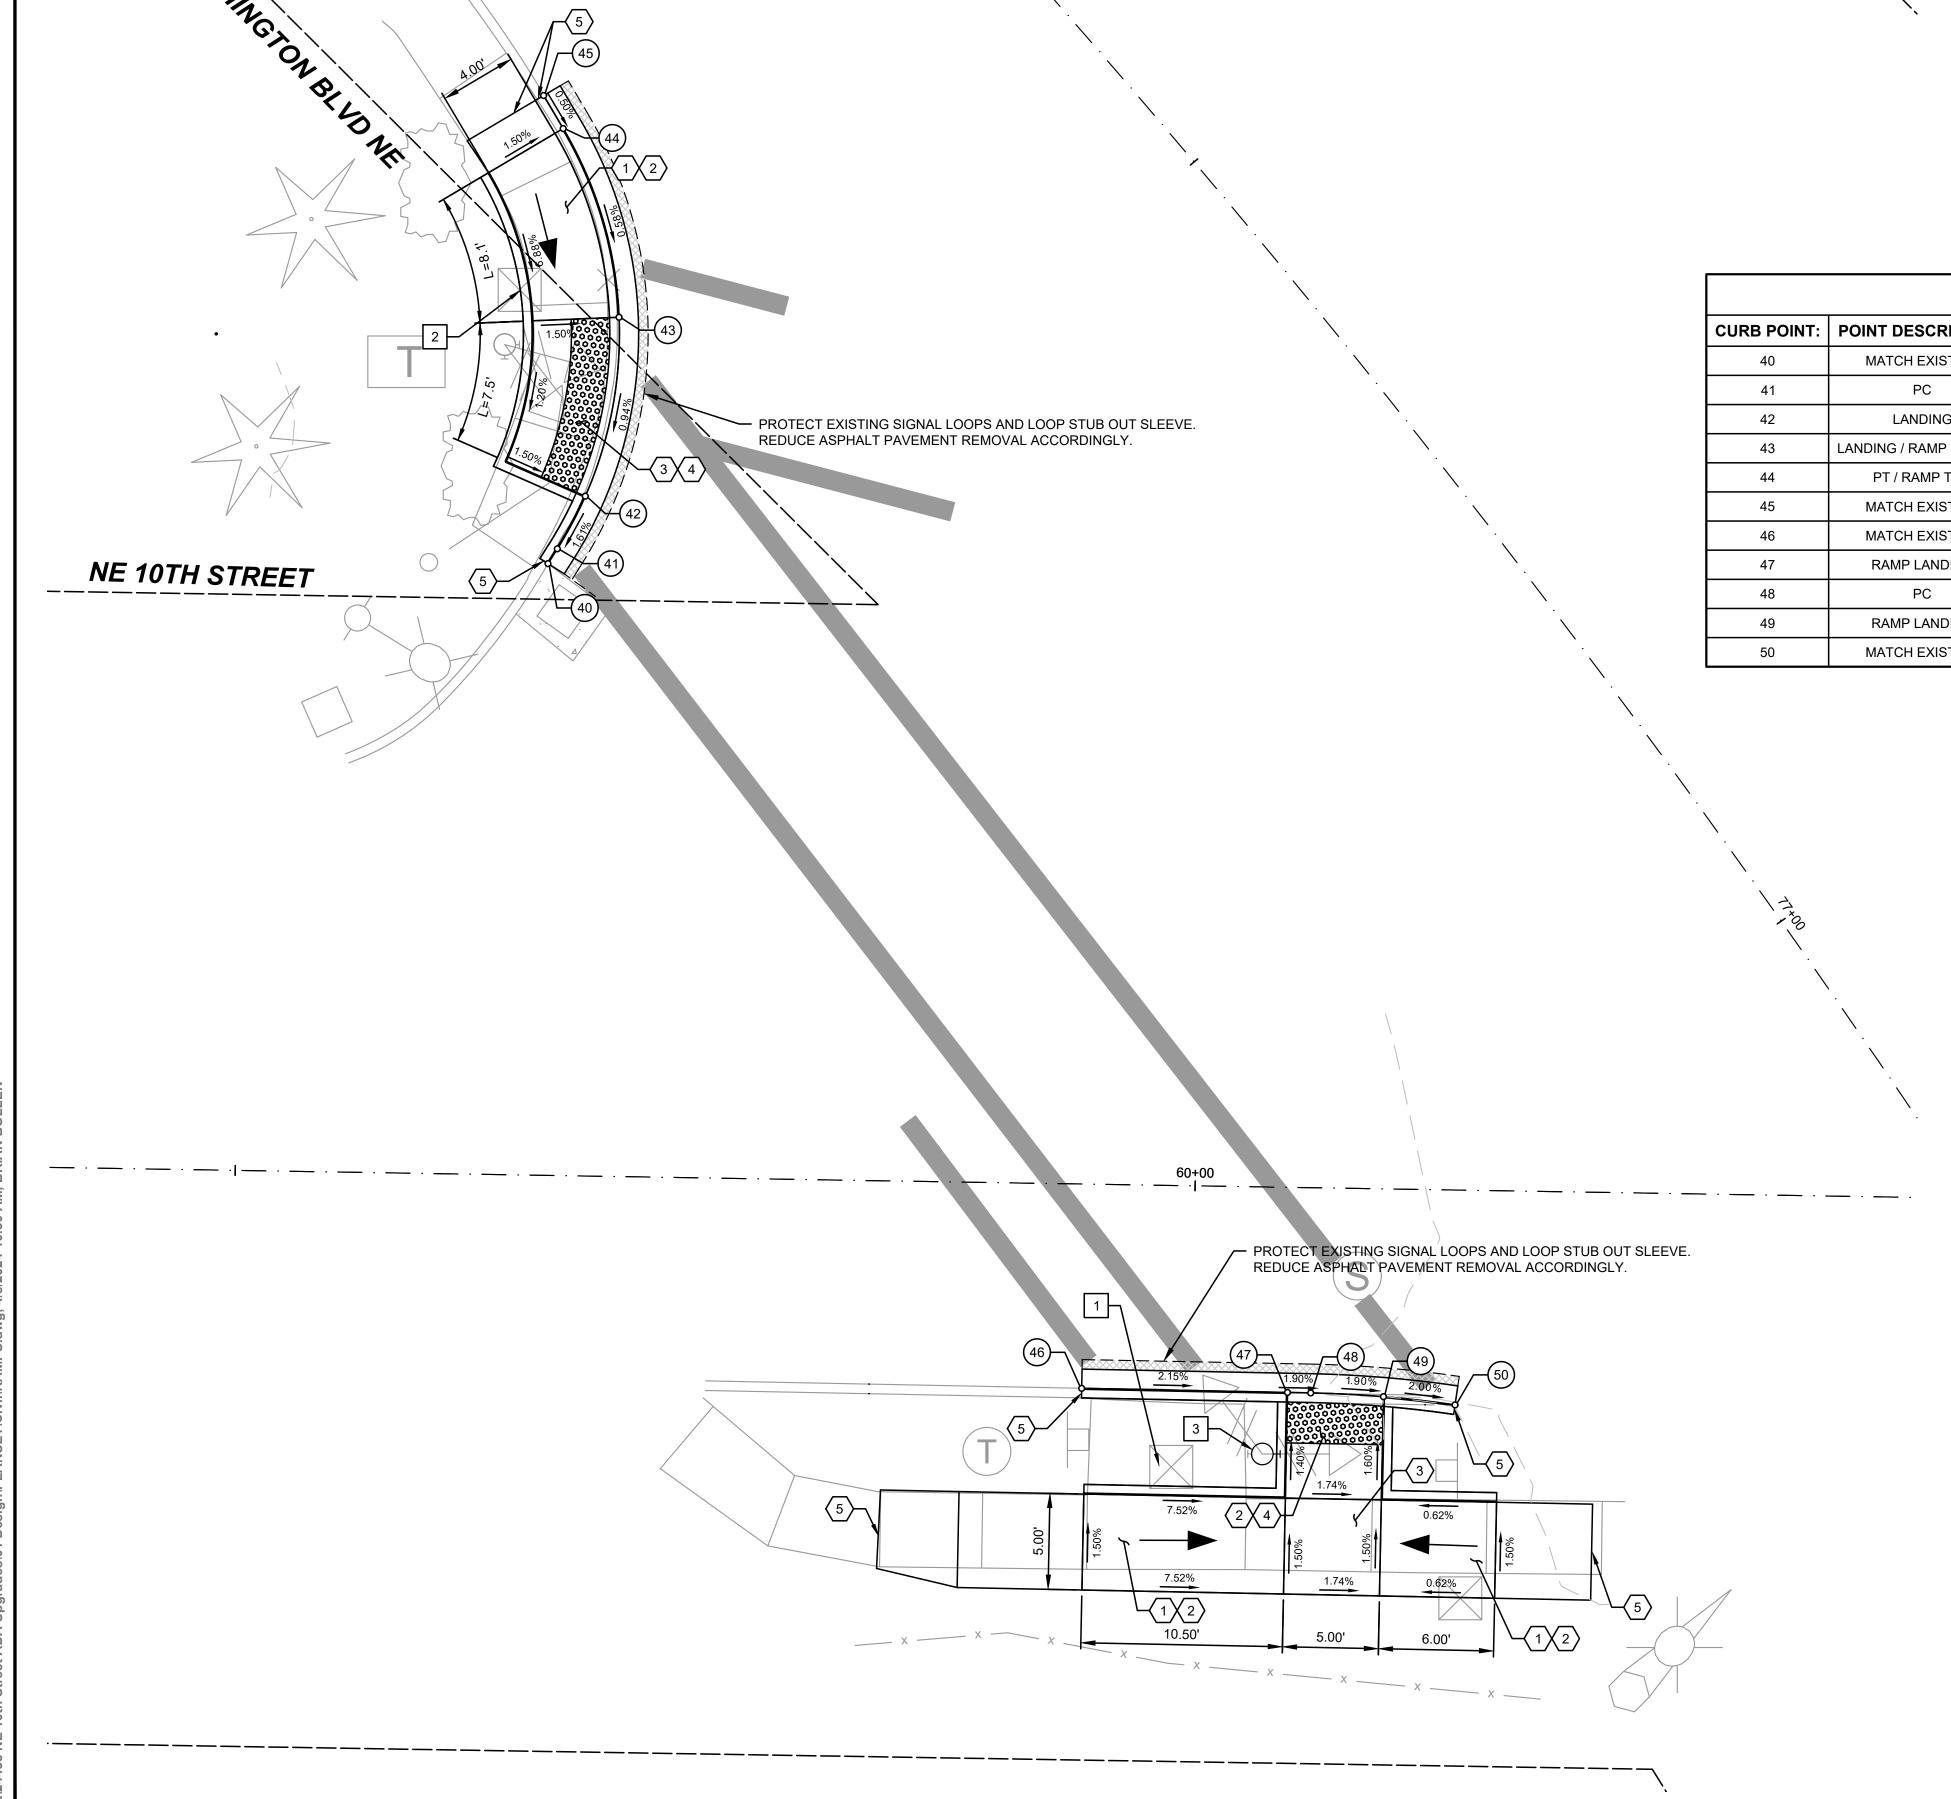
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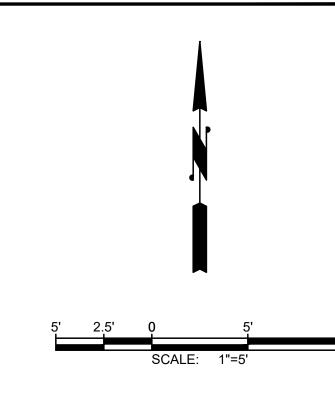
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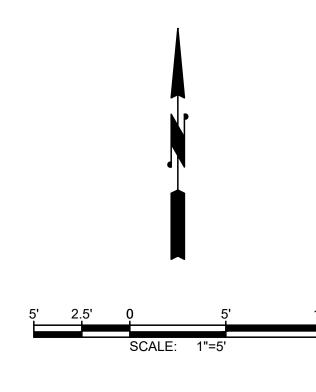
TWO INCHES AT FULL SCALE IF NOT, SCALE ACCORDINGLY

CURB RAMP PLANS (SCHEDULE B)

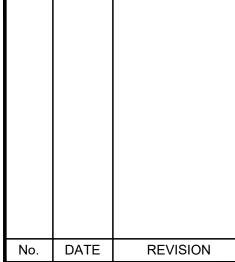SHEET: 13







CURB RAMP 9									
CURB POINT:	POINT DESCRIPTION:	STATION:	OFFSET:	FL. ELEVATION:	CURB HEIGHT:	CURVE DESCRIPTION:	CENTER:		
55	RAMP TOP / MATCH EXISTING	78+14.41	10.71' RT	91.09	6.0"				
56	RAMP BOTTOM / LANDING	78+27.15	11.13' RT	90.67	0.0"				
57	LANDING / MATCH EXISTING	78+33.27	11.23' RT	90.40	0.0"				

- 1. PAVEMENT REPAIR PER TYPICAL ROADWAY CROSS SECTION AND DETAILS, SHEETS 21.
- 2. CURB TYPE AS INDICATED ON THE PLAN. SEE DETAILS, SHEET 22.
- 3. SEE CEMENT CONCRETE SIDEWALK AND JOINTS DETAIL, SHEET 22.
- 4. SEE CURB RAMPS AND DETECTABLE WARNING SURFACE DETAILS, SHEETS 18 AND 19.
- 5. MATCH EXISTING SIDEWALK WIDTH UNLESS INDICATED OTHERWISE.
- 6. ONCE CURB STRING LINES AND/OR FORMS HAVE BEEN SET BY THE CONTRACTOR, THE CONTRACTING AGENCY WILL REVIEW AND APPROVE THE CURB LINES PRIOR TO POURING. THE CONTRACTOR SHALL ANTICIPATE MINOR FIELD ADJUSTMENTS WILL BE REQUIRED AT NO ADDITIONAL COST. THE CONTRACTOR SHALL STRUCTURE HIS BID ACCORDINGLY.

CONSTRUCTION NOTES

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- 2. CURB RAMP. CROSS SLOPE SHALL NOT EXCEED 2.0%, LONGITUDINAL SLOPE SHALL NOT EXCEED 8.33%.
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- 5. SAWCUT EXISTING CURB AND/OR SIDEWALK TO NEAREST FULL JOINT AND PROVIDE CLEAN EDGE.

CHANNELIZATION & SIGNING NOTES

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CITY OF MEDINA

2024 ADA **IMPROVEMENTS & OVERLAY**

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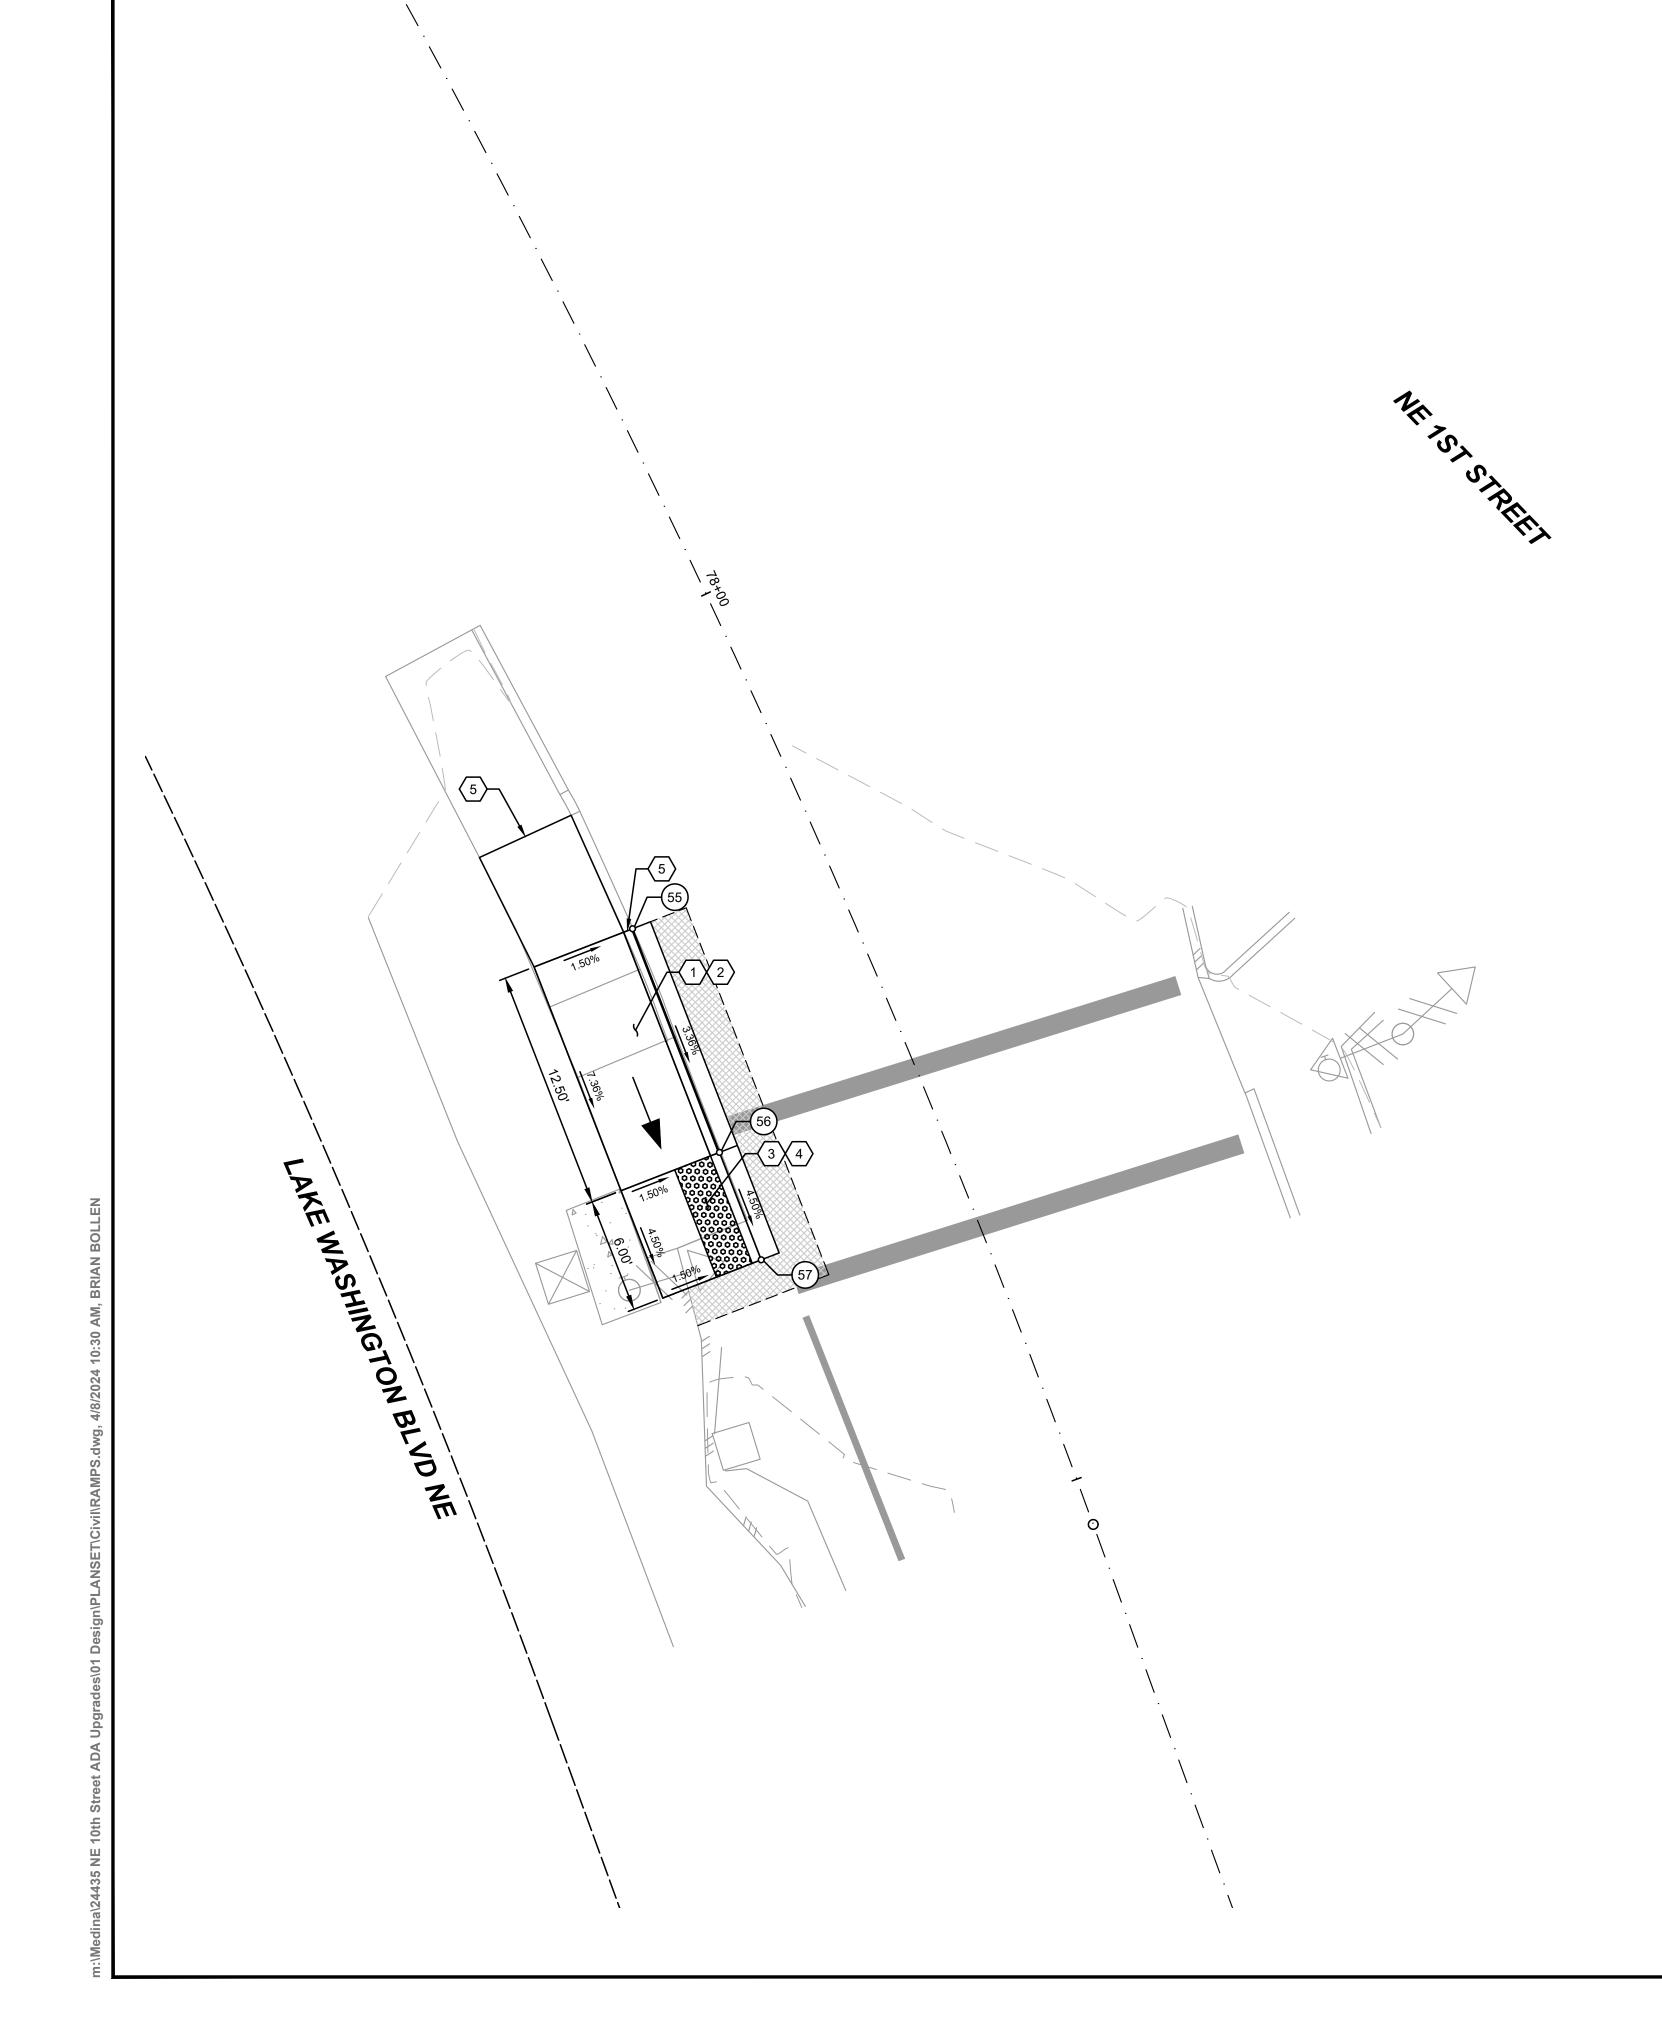
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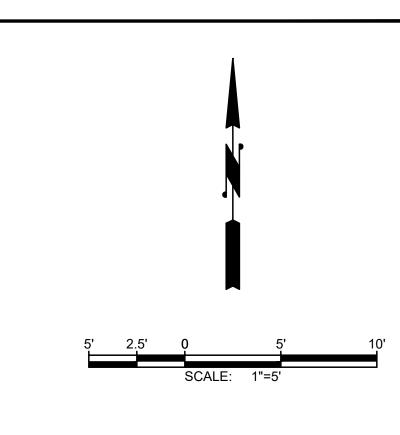
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CURB RAMP PLANS (SCHEDULE B)

SHEET: **14**














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2024 ADA **IMPROVEMENTS & OVERLAY**

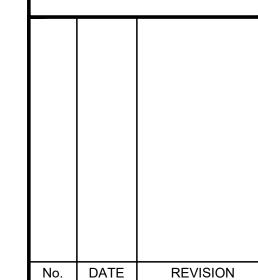

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IF NOT,	SCALE	ACCOR	DINGL'	Y

CURB RAMP PLANS (SCHEDULE C)

OF: **29**

SHEET: **15**

NE 10TH STREET AVE

CURB RAMPS 5 & 6										
CURB POINT:	POINT DESCRIPTION:	STATION:	OFFSET:	FL. ELEVATION:	CURB HEIGHT:	CURVE DESCRIPTION:	CENTER:			
25	MATCH EXISTING	56+76.12	10.85' RT	108.69	6.0"					
26	TOP RAMP / CATCH BASIN	56+77.70	10.86' RT	108.60	6.0"					
27	PC	56+82.11	10.89' RT	108.36	5.0"					
28	LANDING / BOTTOM RAMP	56+94.50	14.43' RT	107.45	0.0"	L=25.25', R=24.00'	56+81.95 34.89 RT			
29	LANDING	56+99.52	18.54' RT	107.22	0.0" / 6.0"	Δ=60°16'44"				
30	MATCH EXISTING	57+02.87	23.14' RT	107.03	0.0"					
31	MATCH EXISTING	57+35.53	26.78' RT	105.20	6.0"					
32	LANDING	57+42.45	16.02' RT	103.44	0.0" / 6.0"	L=29.04', R=22.50' Δ=73°57'01"	57+57.13 33.08 RT			
33	PT / LANDING / BOTTOM RAMP	57+57.21	10.58' RT	102.26	0.0"					
34	RAMP TOP / MATCH EXISTING	57+63.21	10.60' RT	101.87	0.0"					

DETAILS, SHEETS 21.

GENERAL NOTES

- 1. PAVEMENT REPAIR PER TYPICAL ROADWAY CROSS SECTION AND
- 2. CURB TYPE AS INDICATED ON THE PLAN. SEE DETAILS, SHEET 22.
- 3. SEE CEMENT CONCRETE SIDEWALK AND JOINTS DETAIL, SHEET 22. 4. SEE CURB RAMPS AND DETECTABLE WARNING SURFACE DETAILS, SHEETS 18 AND 19.
- 5. MATCH EXISTING SIDEWALK WIDTH UNLESS INDICATED OTHERWISE.
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CONSTRUCTION NOTES

- 1. CONTRACTOR TO FIELD VERIFY AND ADJUST RAMP LENGTH TO MEET RAMP SLOPE REQUIREMENTS PER DETAILS. THE CURB RAMP MAXIMUM RUNNING SLOPE AT THE BACK OF THE RAMP SHALL NOT REQUIRE THE RAMP LENGTH TO EXCEED 15-FEET.
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- 1. REMOVE EXISTING PAVEMENT MARKINGS/LINES.
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- 4. RELOCATE EXISTING SIGNS. FURNISH AND INSTALL NEW HARDWARE AND POST TYPE ST-2 PER DETAIL SHEET 26. WASTEHAUL EXISTING POST AND FOUNDATION.



OVERLAY NOTES

- 1. PROTECT MONUMENT. ADJUST MONUMENT CASE AND COVER TO
- 2. ADJUST WATER VALVE BOX TO GRADE PER DETAIL SHEET 21. CONTRACTOR SHALL COORDINATE WITH UTILITY REPRESENTATIVE.
- 3. ADJUST SEWER MANHOLE TO GRADE PER DETAIL SHEET 21. CONTRACTOR SHALL COORDINATE WITH UTILITY REPRESENTATIVE.
- 4. ADJUST CATCH BASIN TO GRADE PER DETAIL SHEET 21.
- 5. ADJUST WATER METER BOX TO GRADE. CANTRACTOR SHALL COORDINATE WITH UTILITY REPRESENTIVE.
- 6. REPLACE EXISTING HMA "WATER BAR" TO MAINTAIN EXISTING RUNOFF PATTERN.
- 7. SAWCUT EXISTING CEMENT CONCRETE DRIVEWAY AND REMOVE AND WASTEHAUL.

¬ PAVEMENT MARKING NOTES:


1. FURNISH AND INSTALL A BLUE TYPE 2 RPM, MATCH EXISTING LOCATION.

GENERAL NOTES:

- 1. ALL PLASTIC PAVEMENT MARKINGS SHALL BE TYPE D-1 MMA UNLESS INDICATED OTHERWISE.
- 2. FURNISH AND INSTALL TEMPORARY PAVEMENT MARKINGS IMMEDIATELY FOLLOWING PAVING.





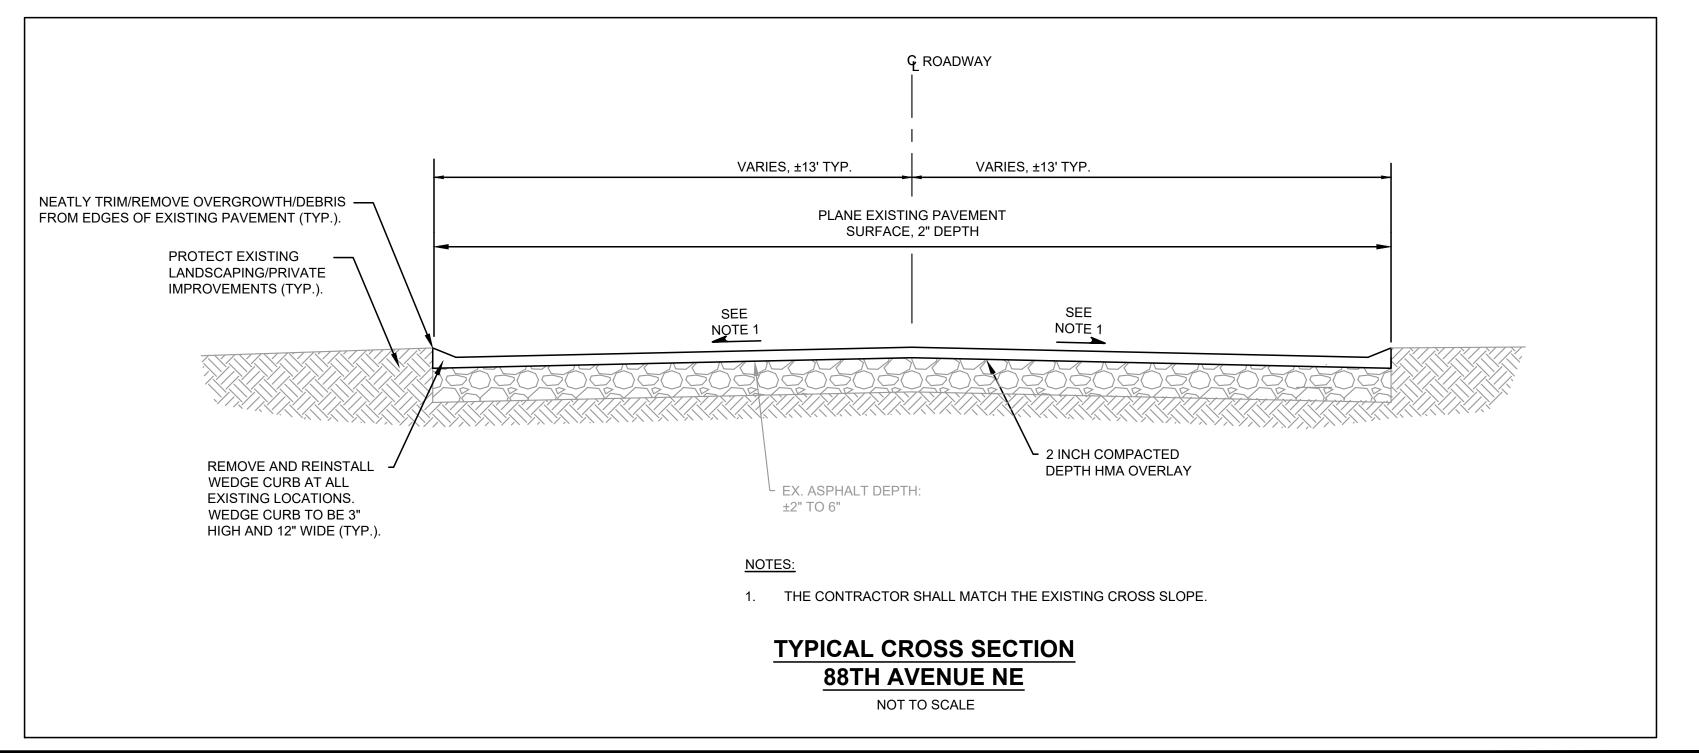

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(206) 284-0860





CITY OF MEDINA 2024 ADA **IMPROVEMENTS & OVERLAY**

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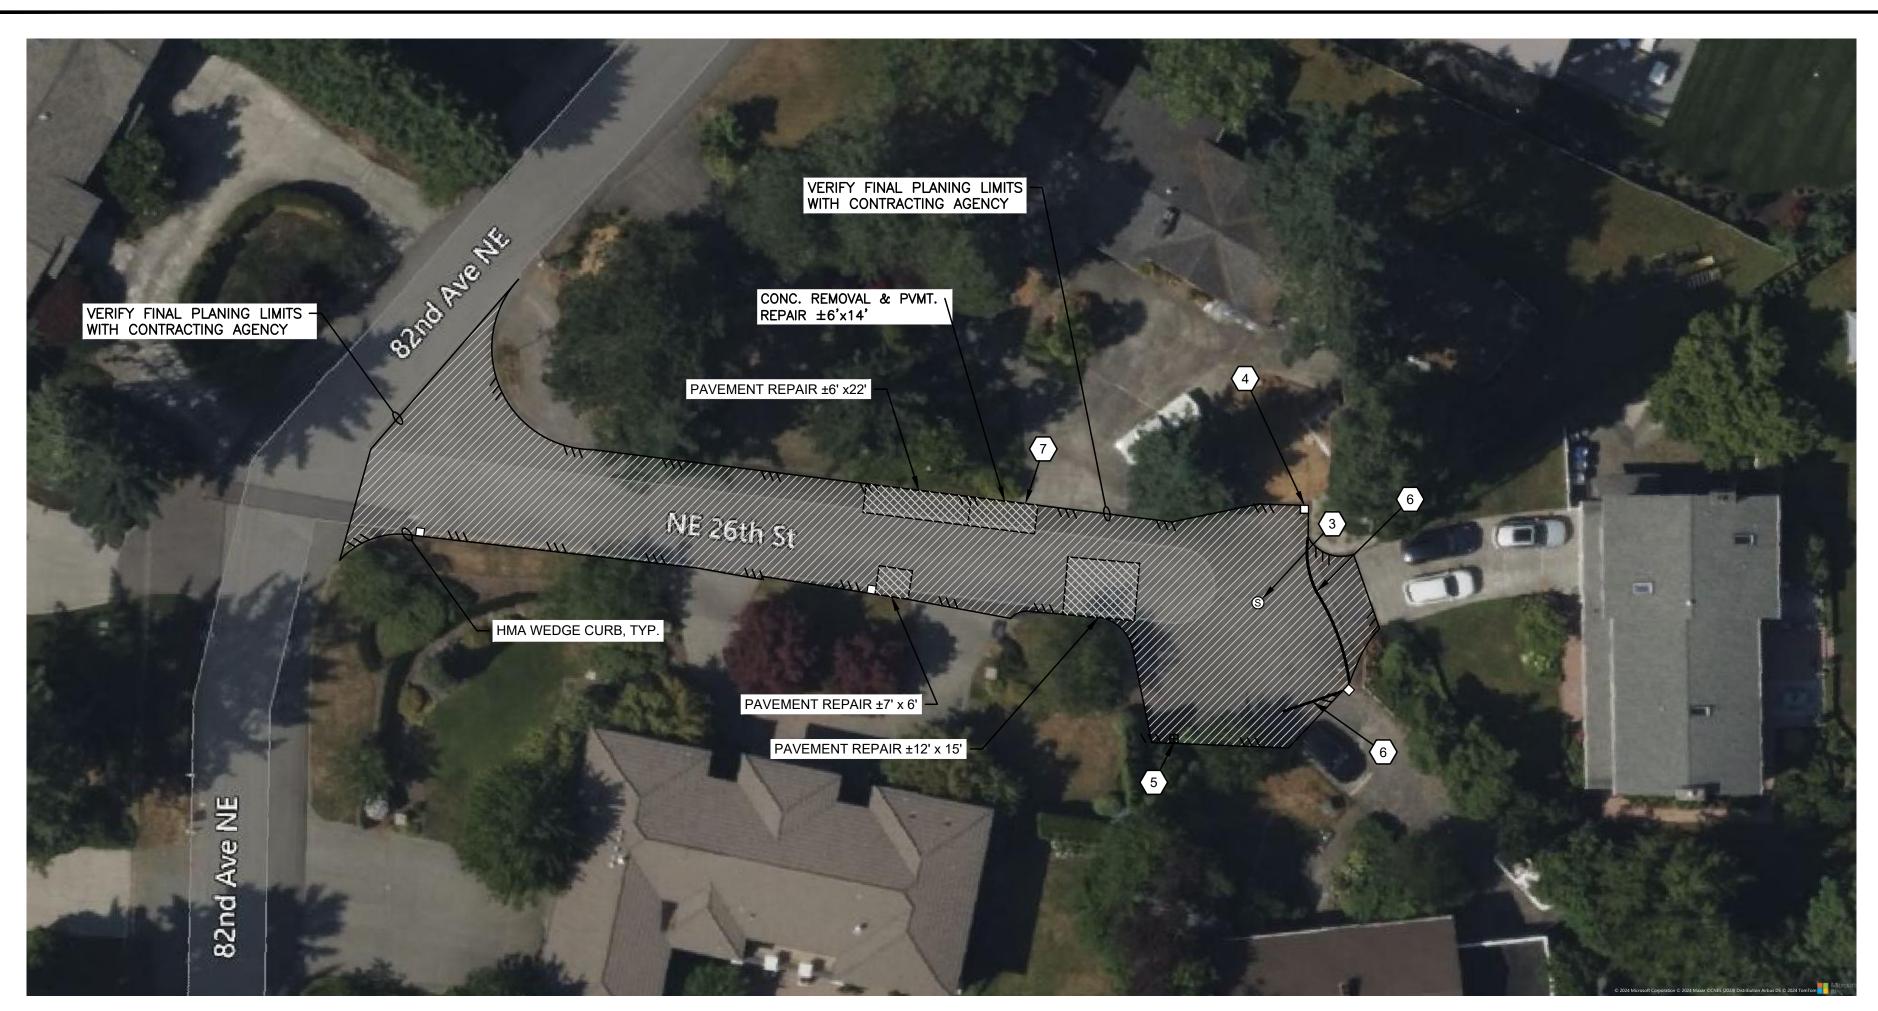
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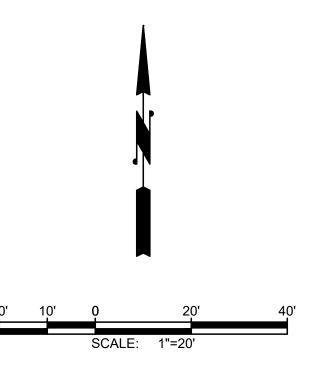
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G & O JOB NO.:	24432
FILE:	C_PLAN.DWG


TWO INCHES AT FULL SCALE. IF NOT, SCALE ACCORDINGLY

> 88TH AVE NE **OVERLAY** (SCHEDULE C)

OF: **29**





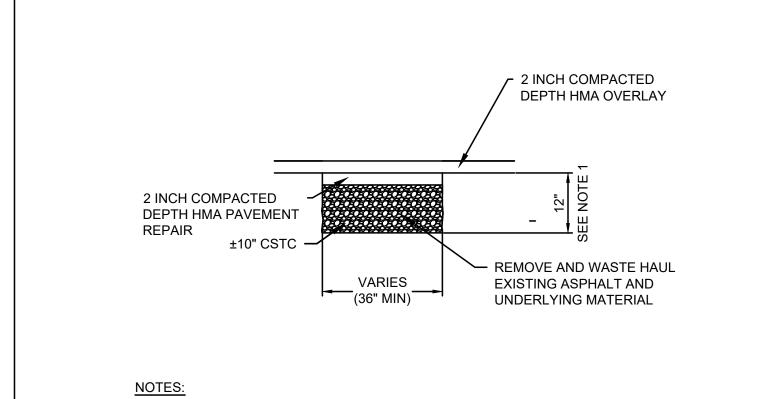

- 1. PAYMENT FOR EXCAVATION AND WASTE HAUL OF EXISTING MATERIAL WITHIN THE FIRST 12-INCHES BELOW EXISTING GRADE WILL BE MADE UNDER THE UNIT CONTRACT PRICE PER SQUARE YARD FOR "PAVEMENT REPAIR EXCAVATION INCL. HAUL"
- 2. AREAS TO BE REPAIRED TO BE MARKED IN FIELD BY CONTRACTING AGENCY.

PAVEMENT REPAIR DETAIL

NOT TO SCALE

OVERLAY NOTES


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- 7. SAWCUT EXISTING CEMENT CONCRETE DRIVEWAY AND REMOVE AND WASTEHAUL.

PAVEMENT MARKING NOTES:

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- 2. FURNISH AND INSTALL TEMPORARY PAVEMENT MARKINGS IMMEDIATELY FOLLOWING PAVING.




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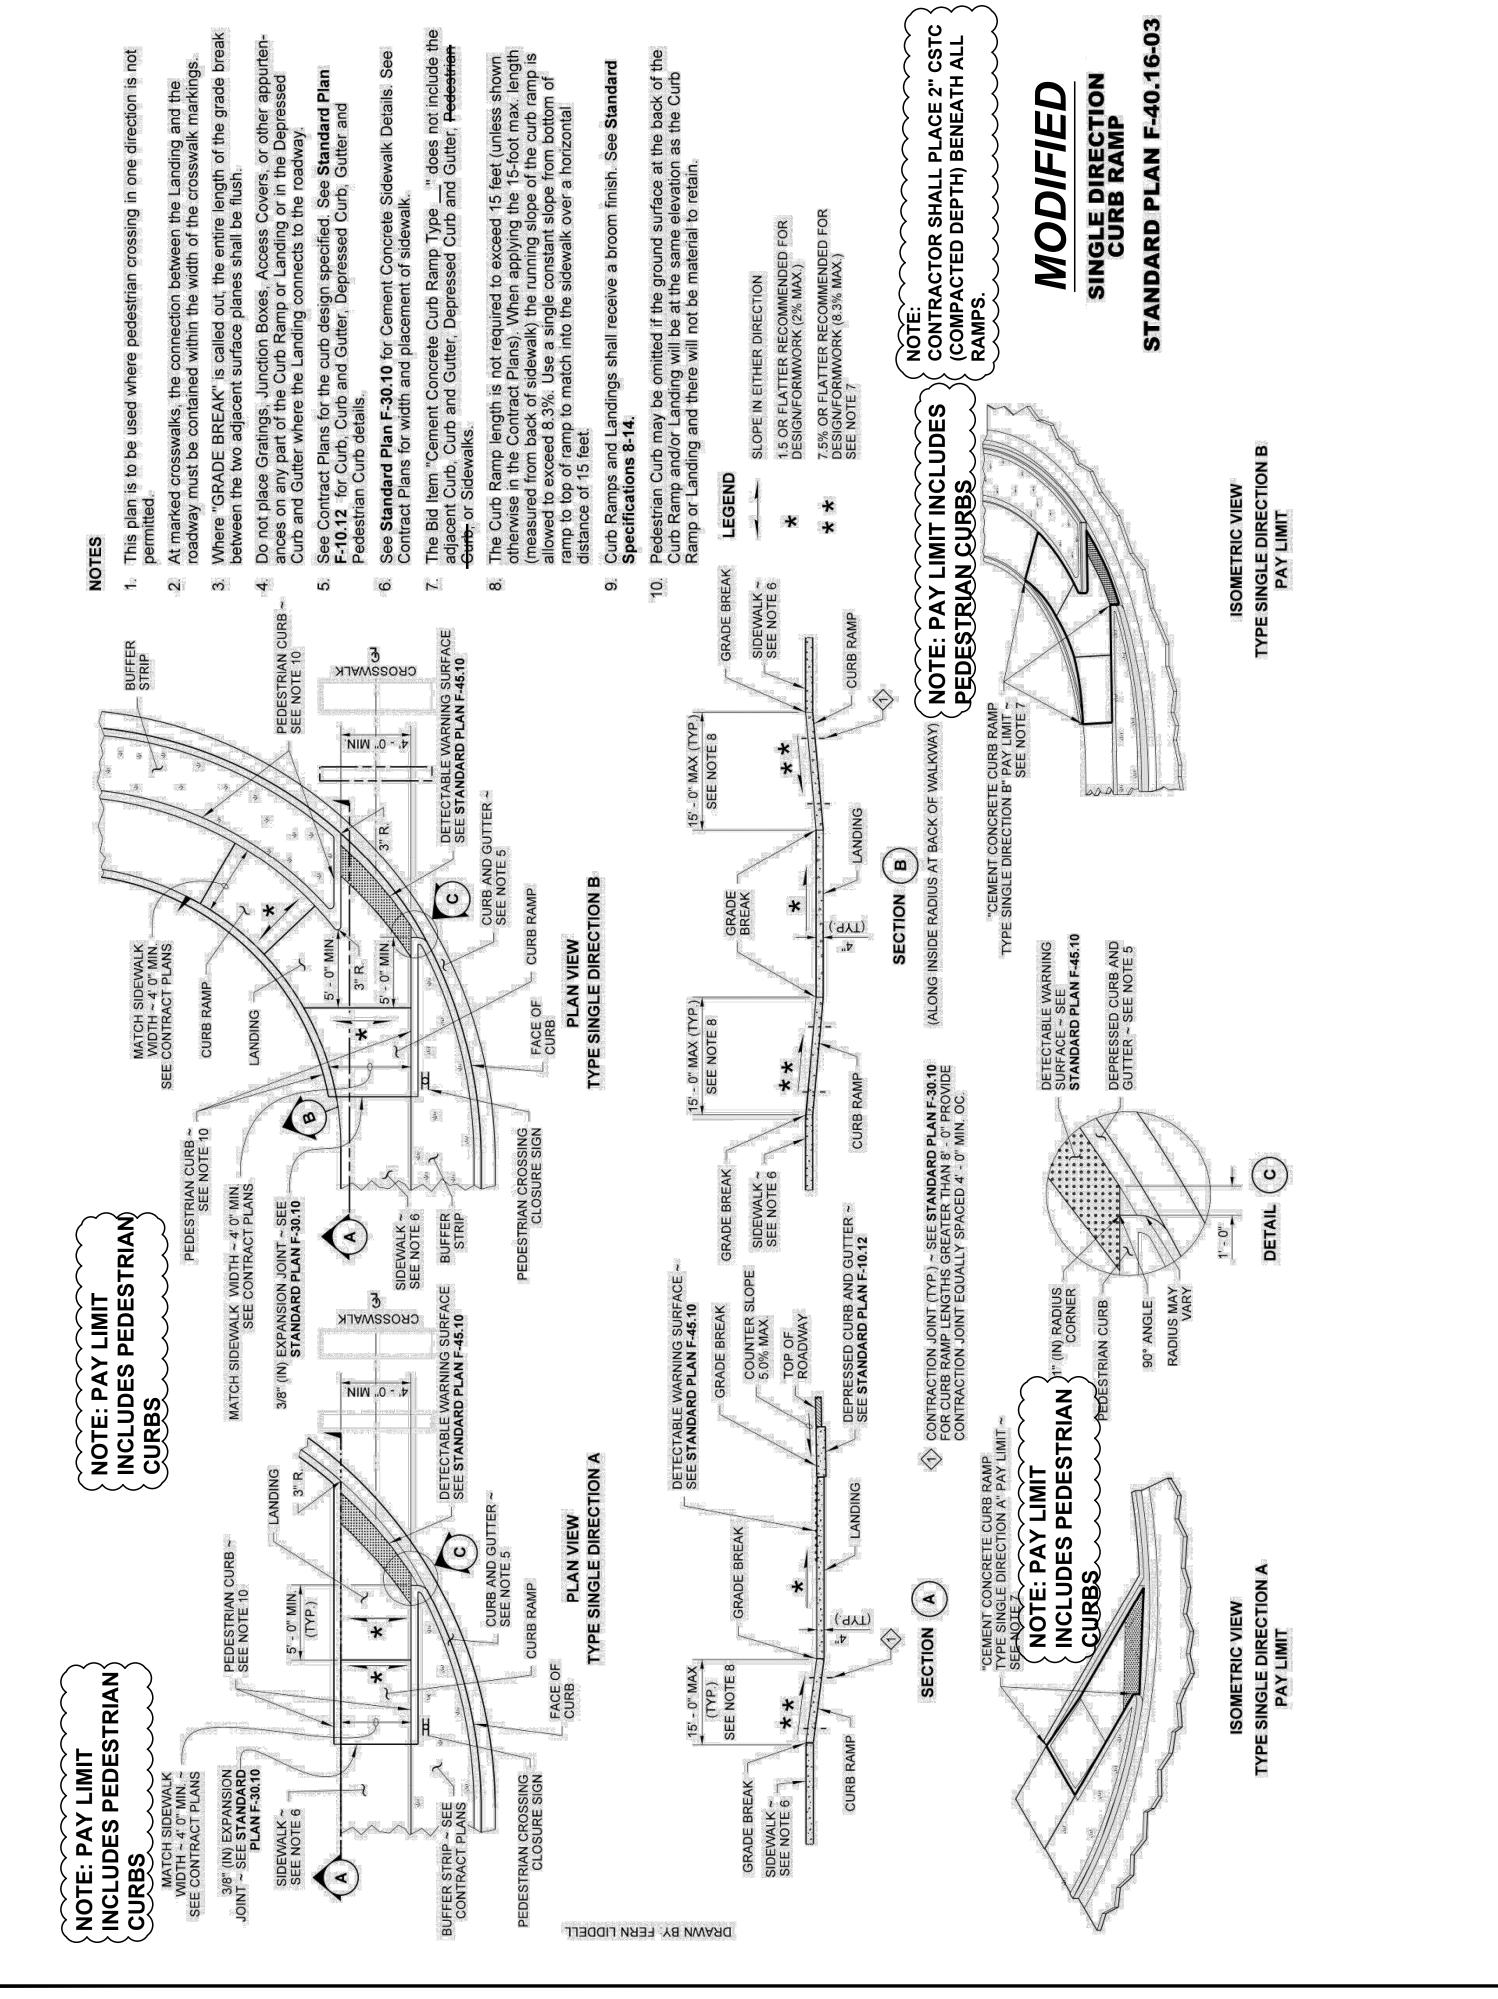
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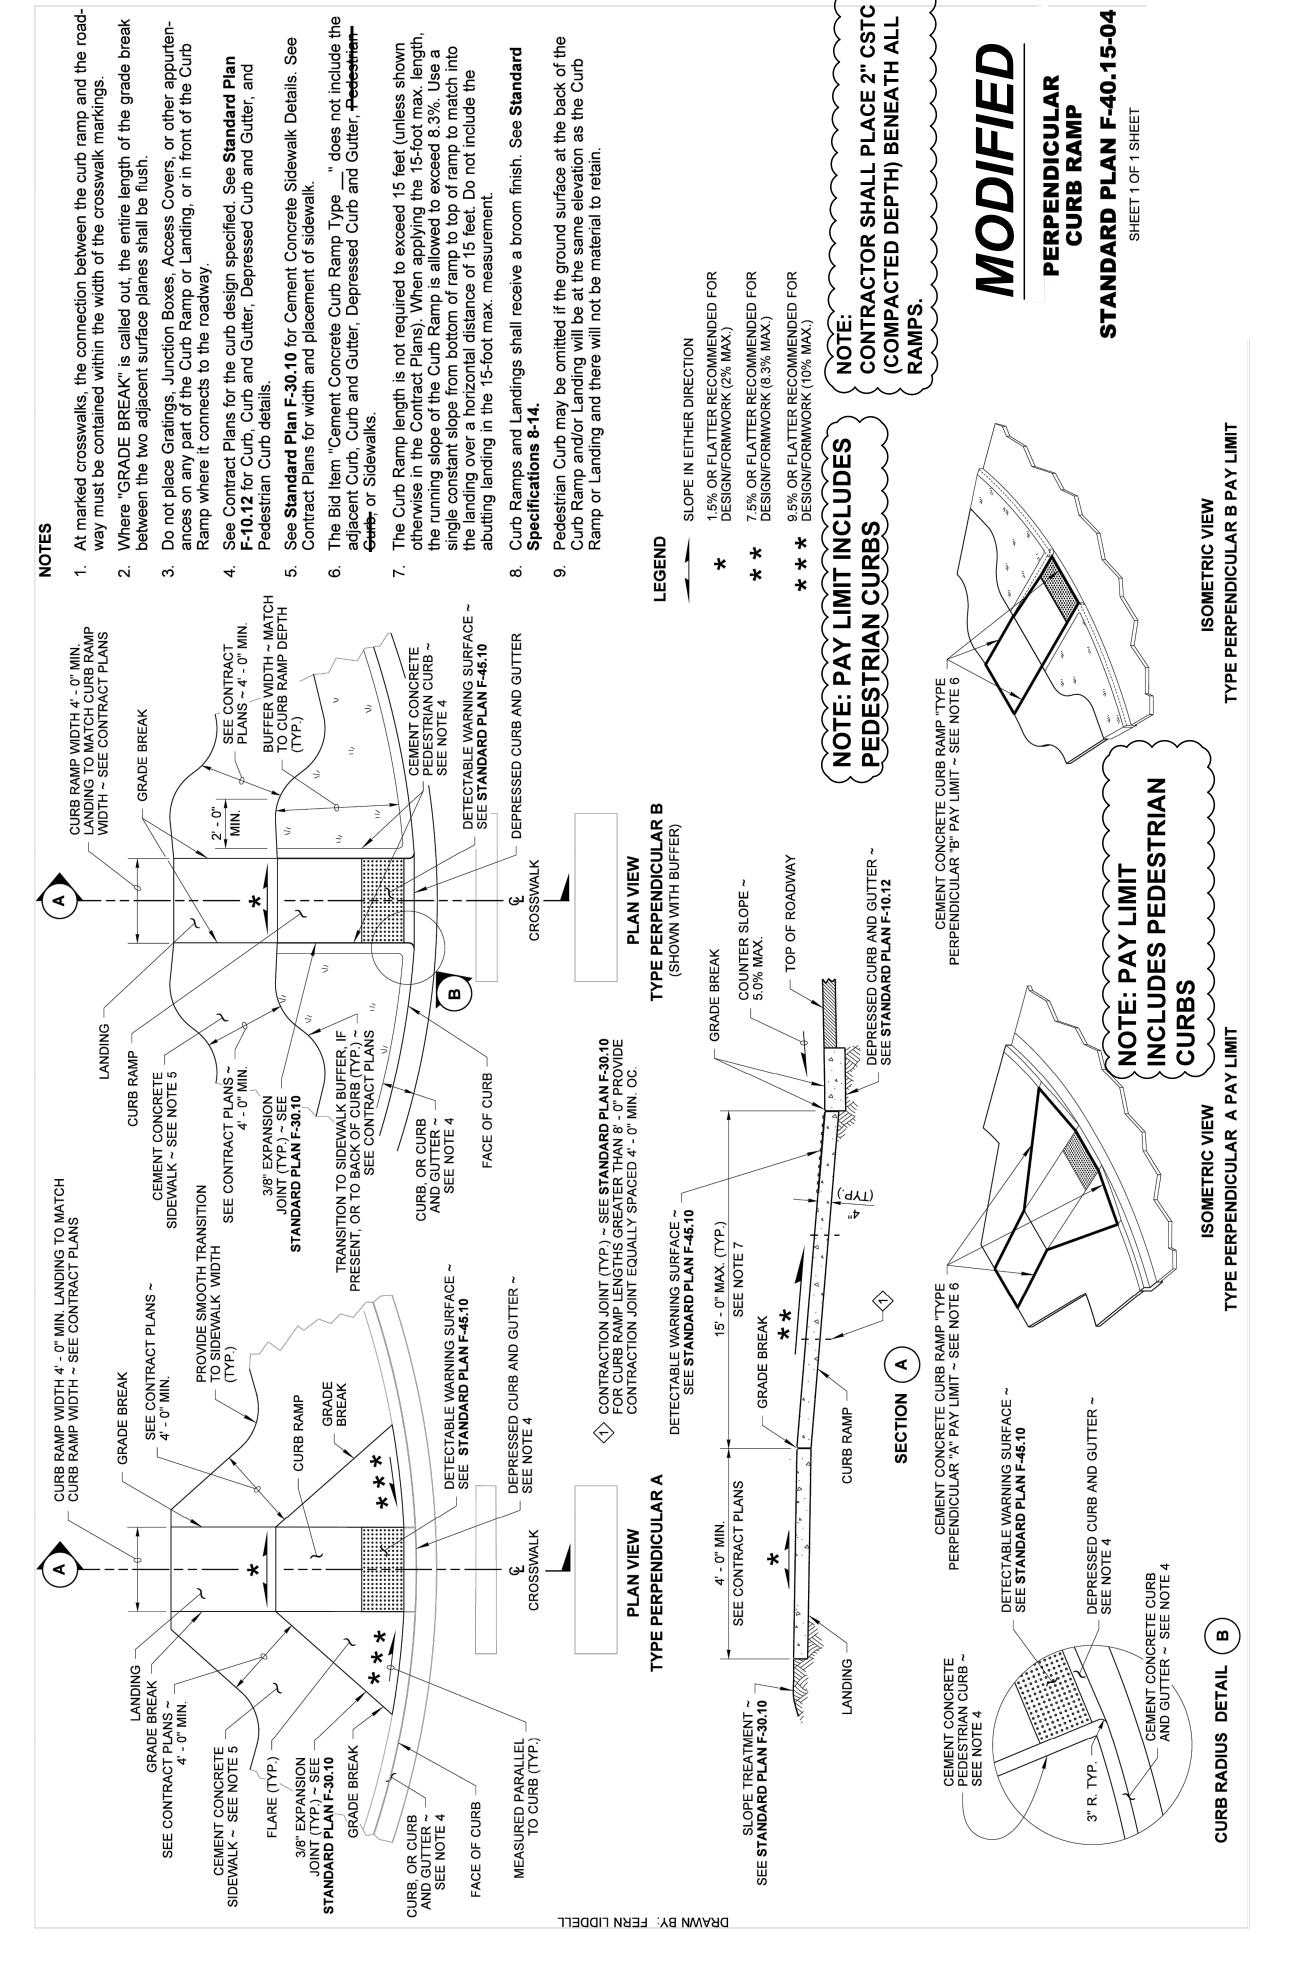
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TWO INCHES AT FULL SCALE. IF NOT, SCALE ACCORDINGLY

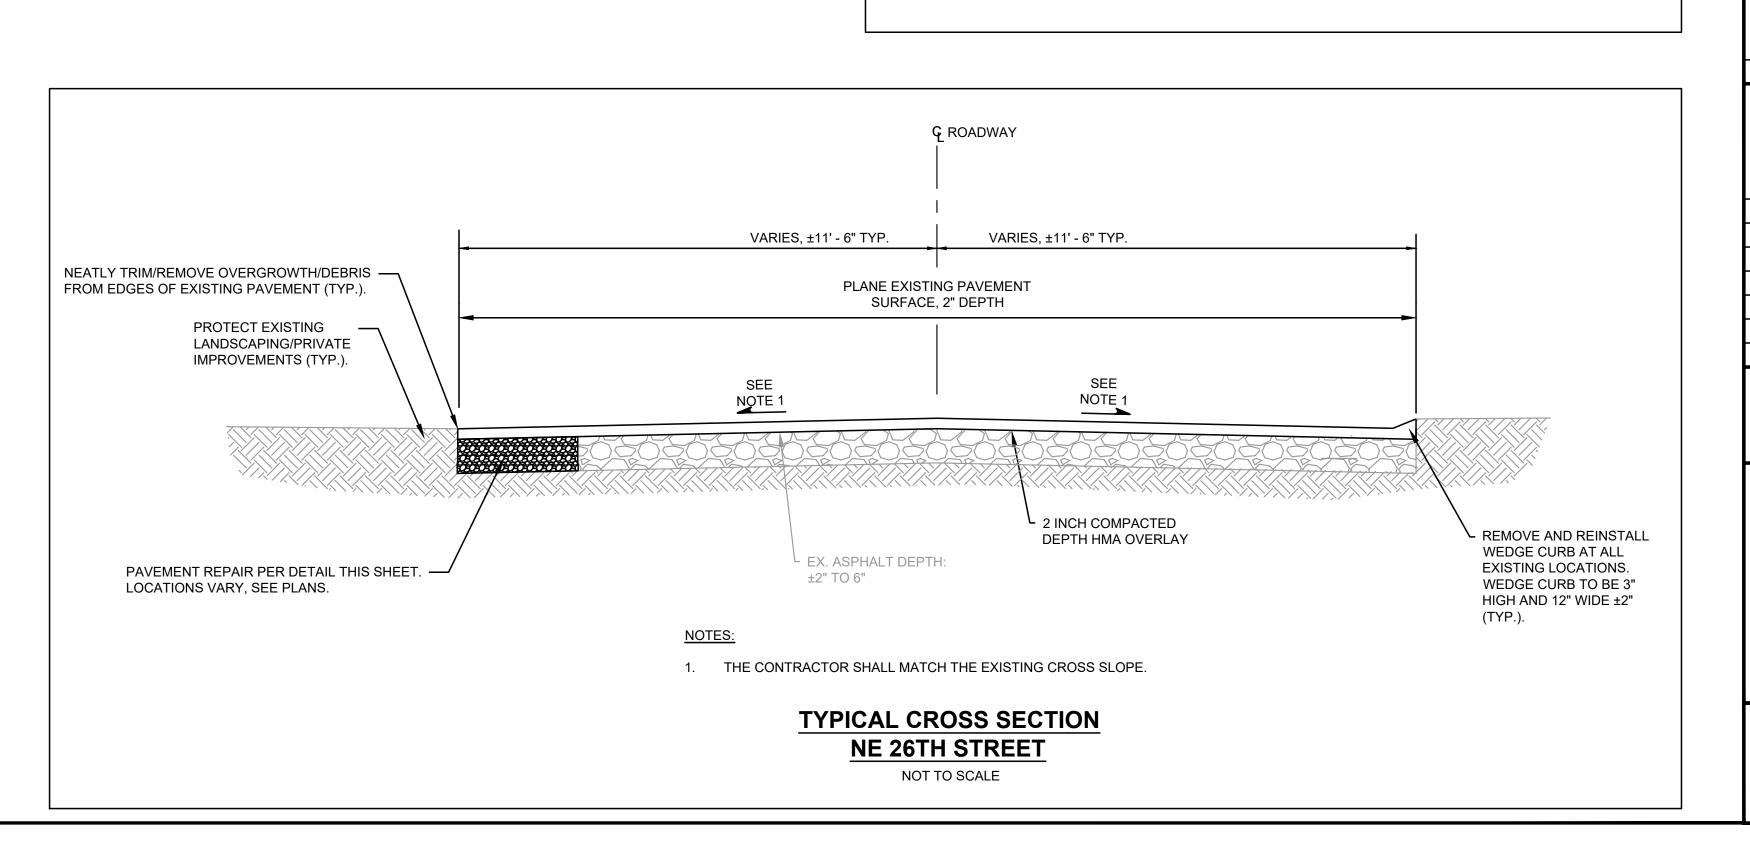NE 26TH ST OVERLAY (SCHEDULE C)

SHEET: **17**



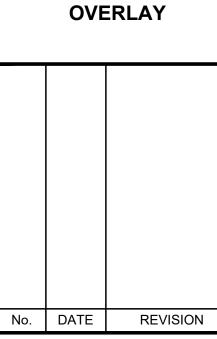



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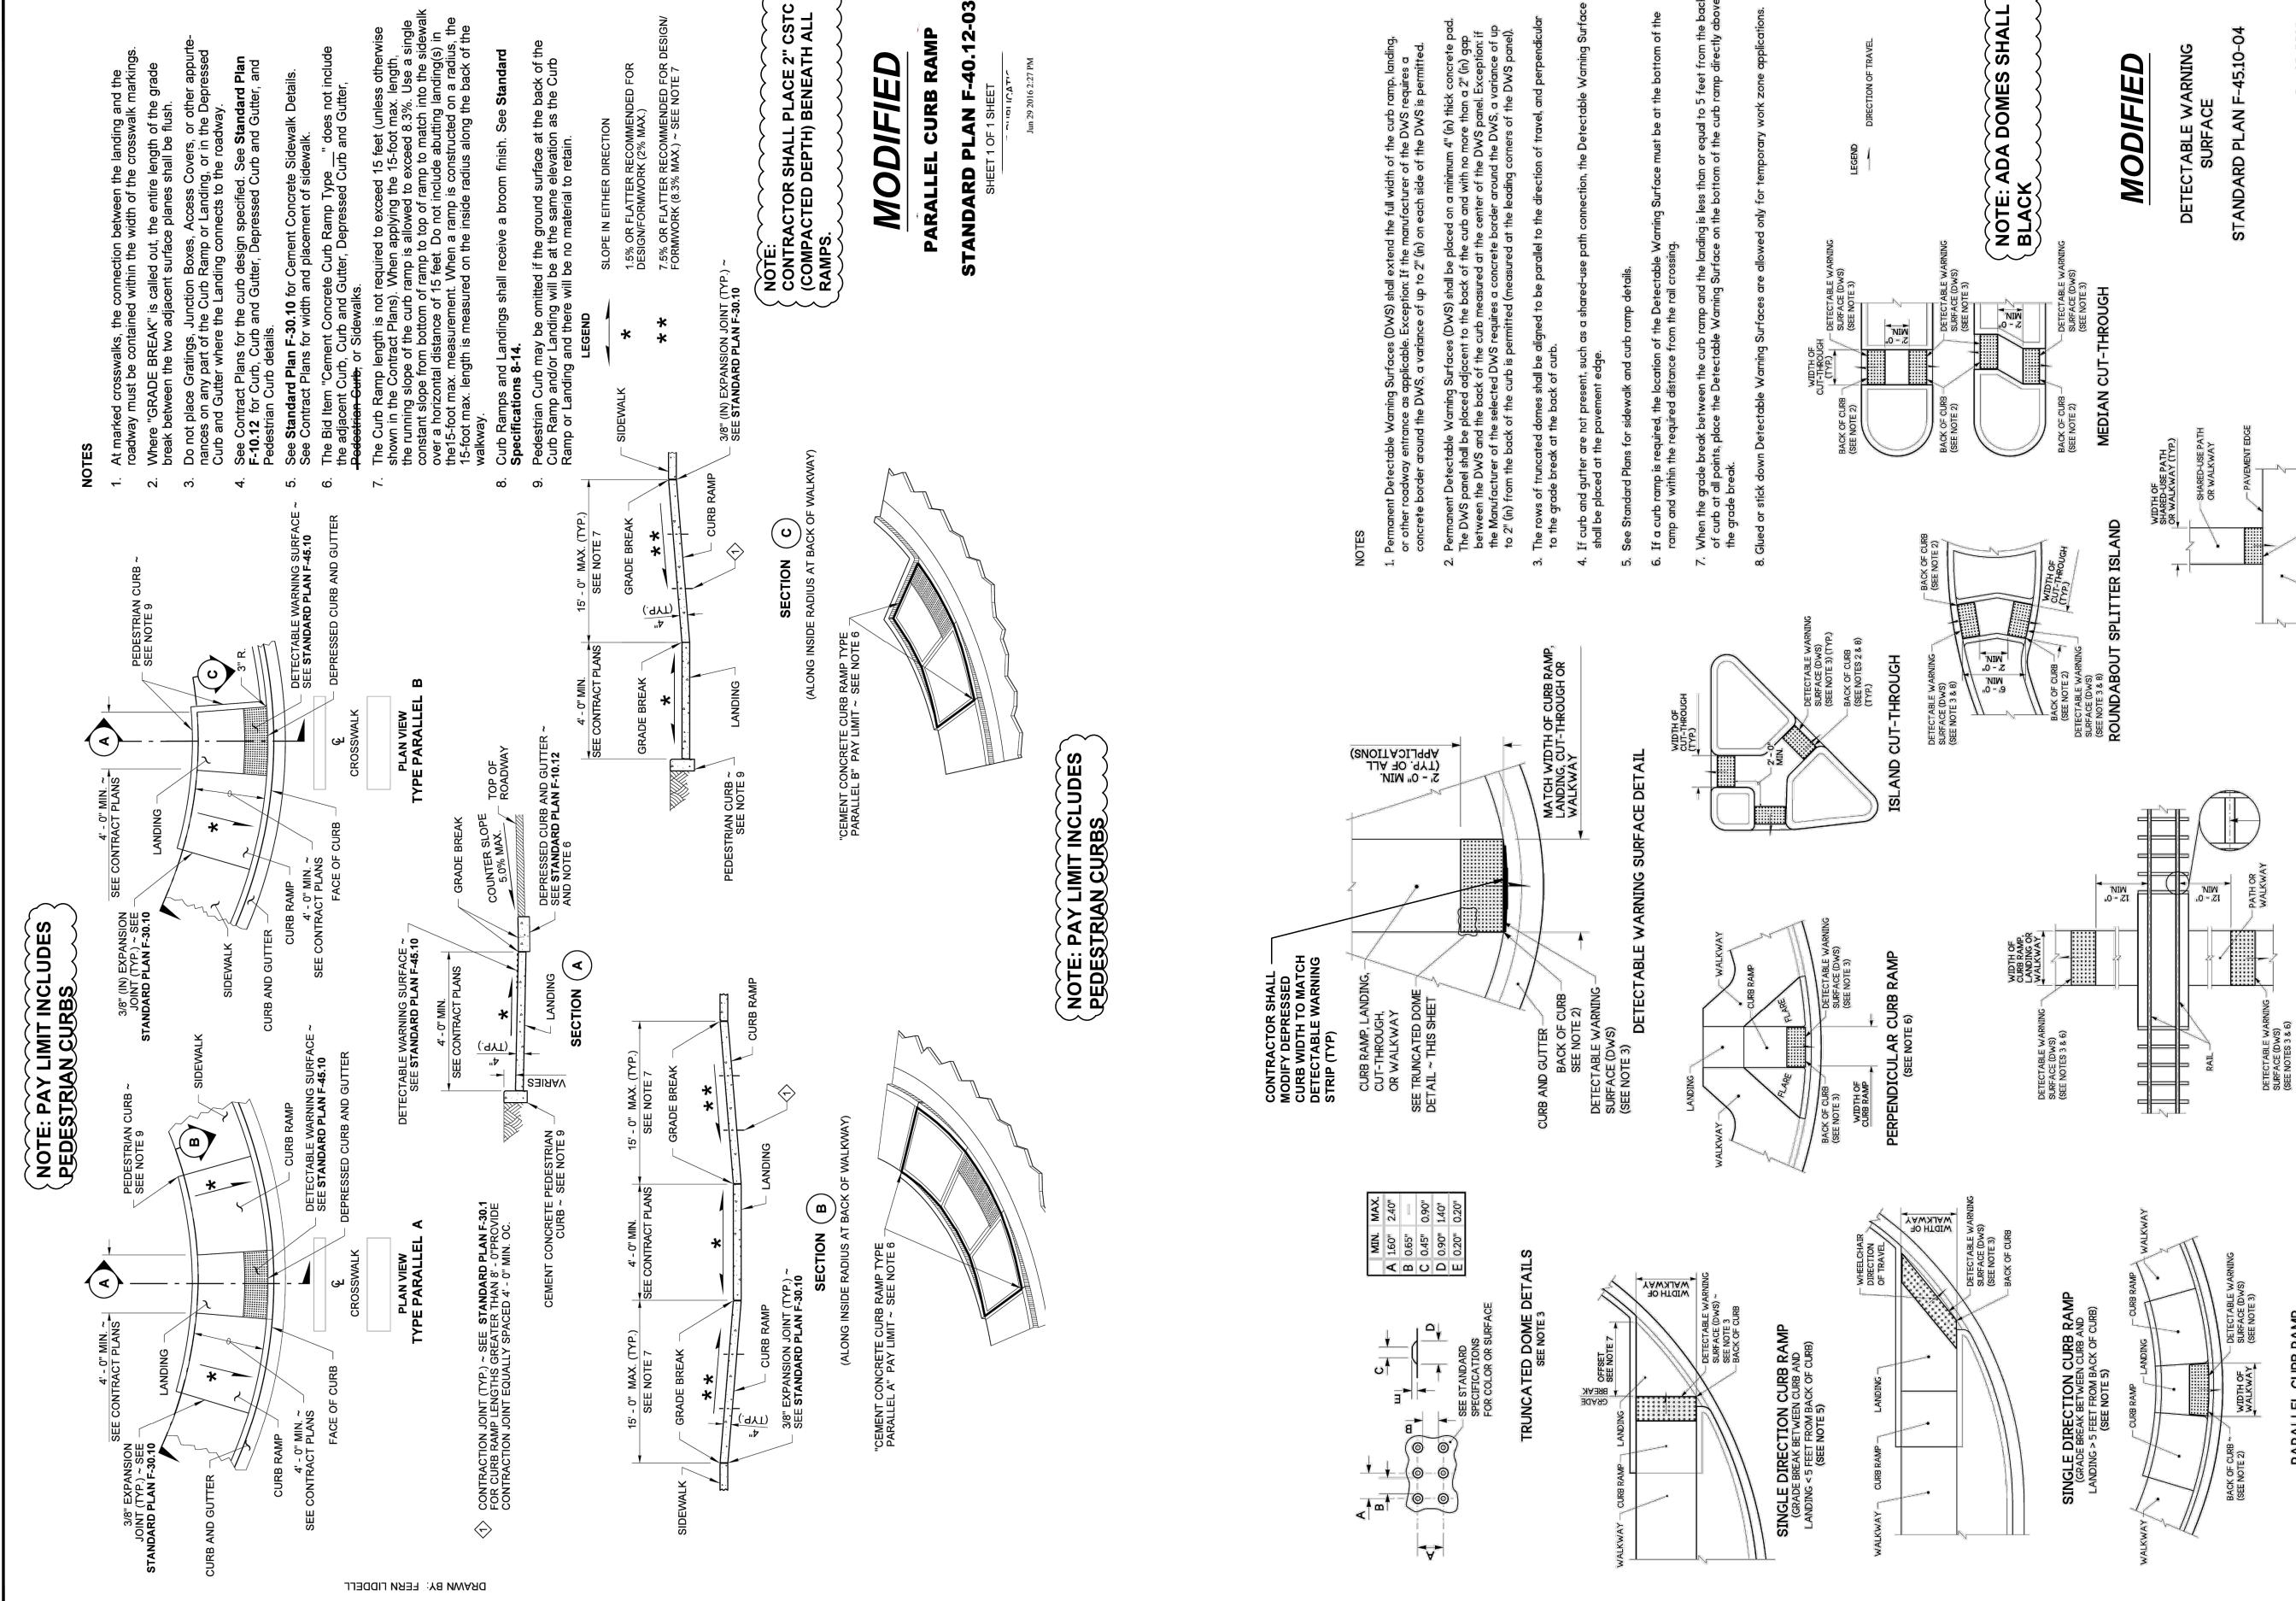
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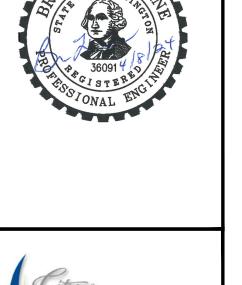
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DESIGNER:

CURB RAMP DETAILS

SHEET: **18**





CITY OF MEDINA

2024 ADA IMPROVEMENTS & OVERLAY

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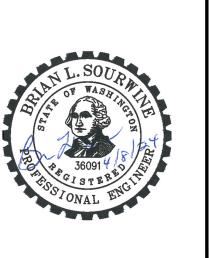
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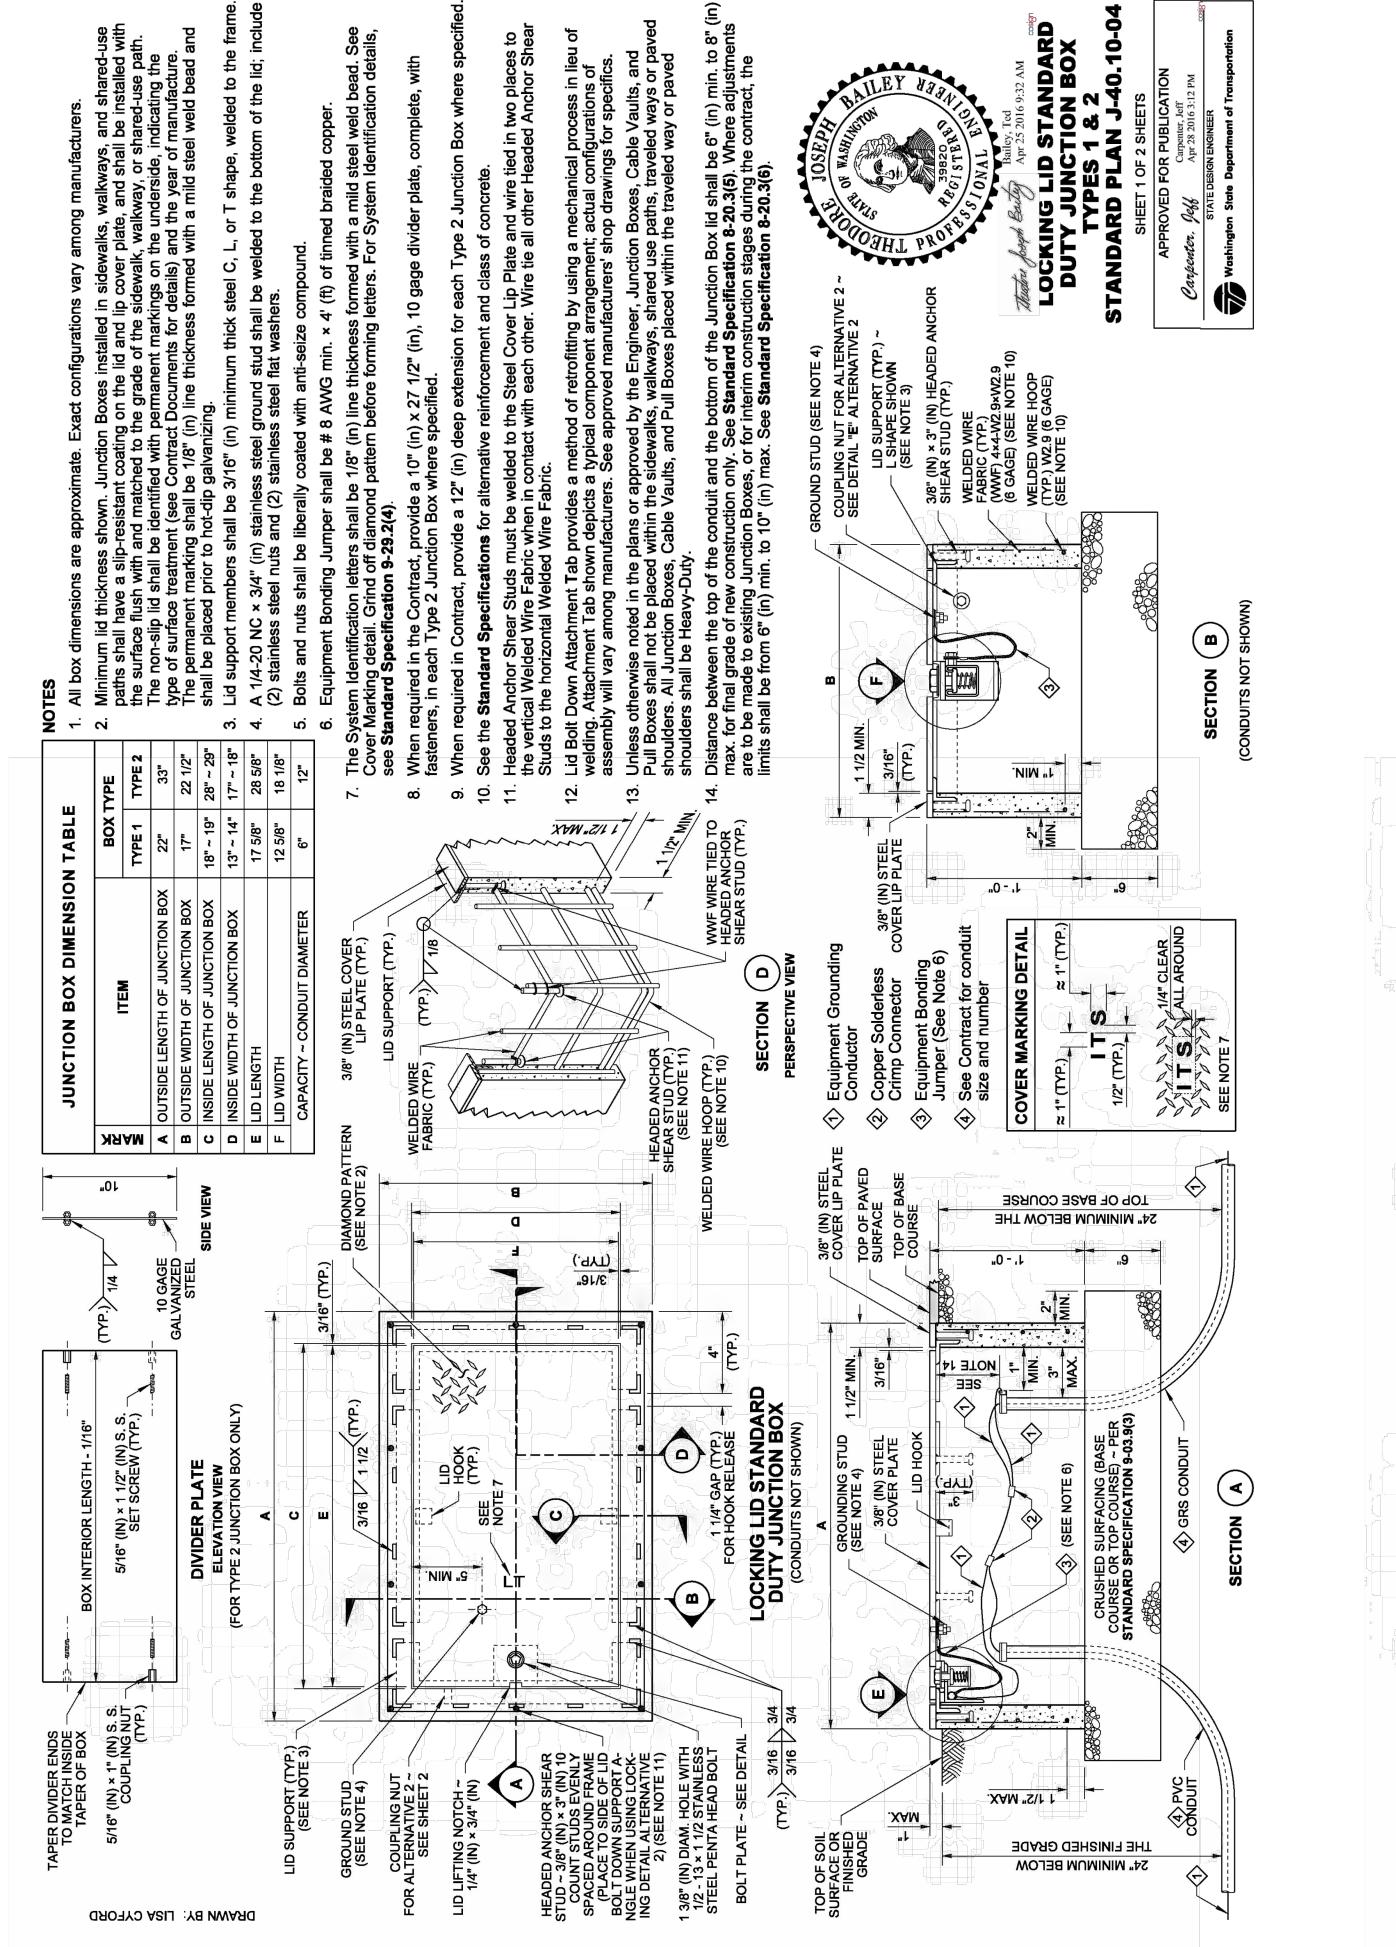



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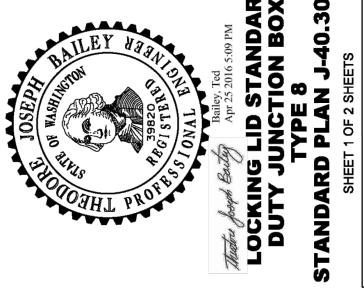
Gray & Osborne, Inc.

CURB RAMP DETAILS

SHEET: **19**





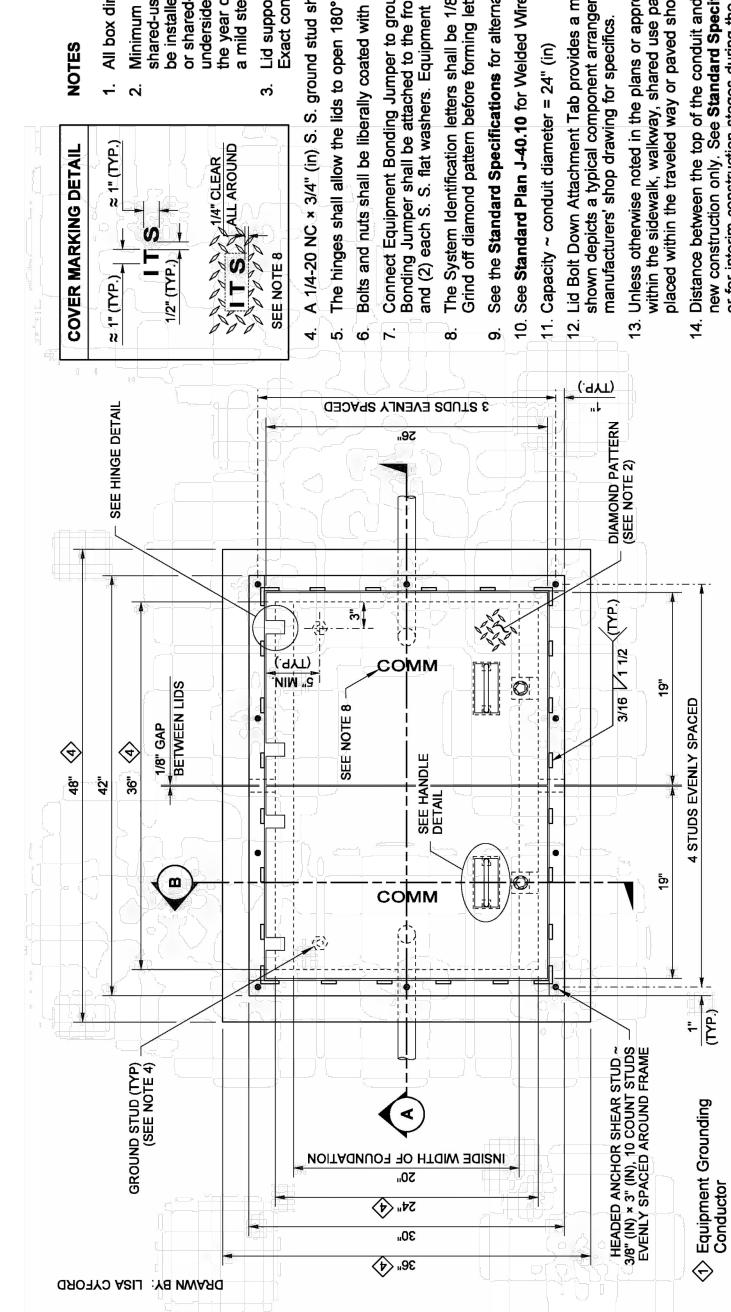

SEE

1/2" (IN) STEEL COVER PLATE (TYP.)

 \bigcirc

.XAM

Cong Conr Conr (c) Equip (c) Equip (c) See (c)

THE FINISHED GRADE

54" MINIMUM BELOW

Gray & Osborne, Inc.

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2024 ADA

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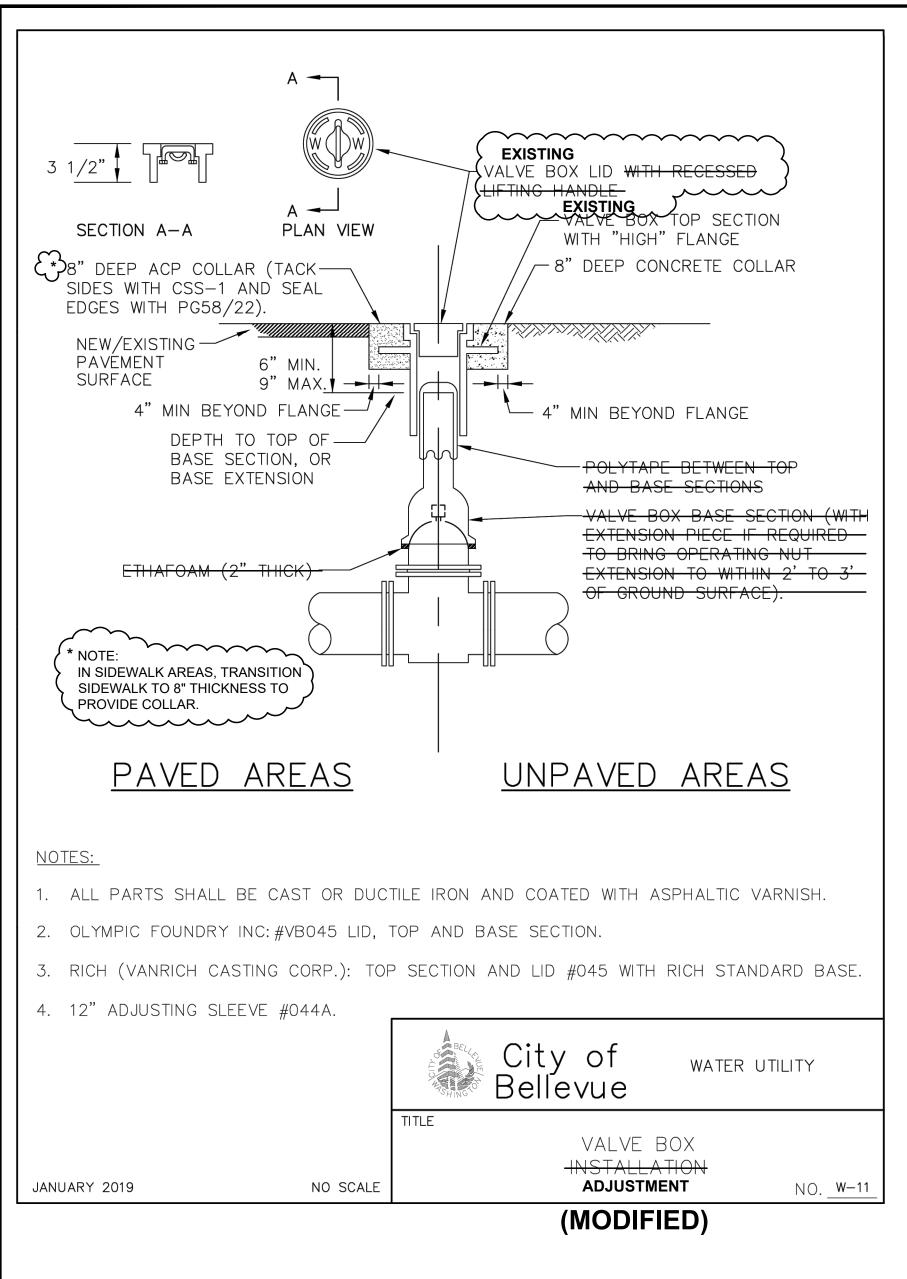
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DESIGNER:

G & O JOB NO.:

ROADWAY DETAILS

SHEET: **20**



DRIVEWAY REPAIR DEPRESSED CURB -LENGTH AND MATERIAL AND GUTTER PER PLAN SEE PLANS VARIES 1/2" LIP, TYP. — EXISTING DRIVEWAY FINISHED ROAD -**B** SECTION - VARIES (SEE PLANS) 12H:1V MAX 12H:1V MAX - CEMENT CONCRETE SIDEWALK - 3/8" EXPANSION JOINT (TYP.) - DRIVEWAY REPAIR (SEE PLANS) PAY LIMITS (TYP.) CURB & GUTTER **CEMENT CONCRETE ISOMETRIC VIEW**

1. WHEN THE DRIVEWAY WIDTH EXCEEDS 15 FEET, CONSTRUCT A FULL DEPTH EXPANSION JOINT WITH 3/8" JOINT FILLER ALONG THE DRIVEWAY CENTERLINE. CONSTRUCT EXPANSION JOINTS PARALLEL WITH THE CENTERLINE AS REQUIRED AT 15' MAXIMUM SPACING WHEN DRIVEWAY WIDTHS EXCEED 30'


2. CEMENT CONCRETE DRIVEWAY SHALL BE CL 4000.

CEMENT CONCRETE DRIVEWAY ENTRANCE

NOT TO SCALE

DRIVEWAY SCHEDULE

	LOCATION			CONC	RETE DRIVI	EWAY ENTR	DRIVEWAY REPAIR (BEYOND ENTRANCE)		
STDEET	DRIVEWAY	/AY CENTER SIDE		WIDTH "A"	AREA	RAMP LENGTH (FT)		MATERIAL	AREA (SY)
STREET	#			WIDIN A	(SY)	LEFT	RIGHT	WATERIAL	AINLA (ST)
NE 24TH ST	1	13+27.2	LEFT	22'	22.0	5	5	HMA	4.1
NE 10TH ST	2	53+65.9	RIGHT	18.5"	10.5	7.5	6.5	НМА	26.7

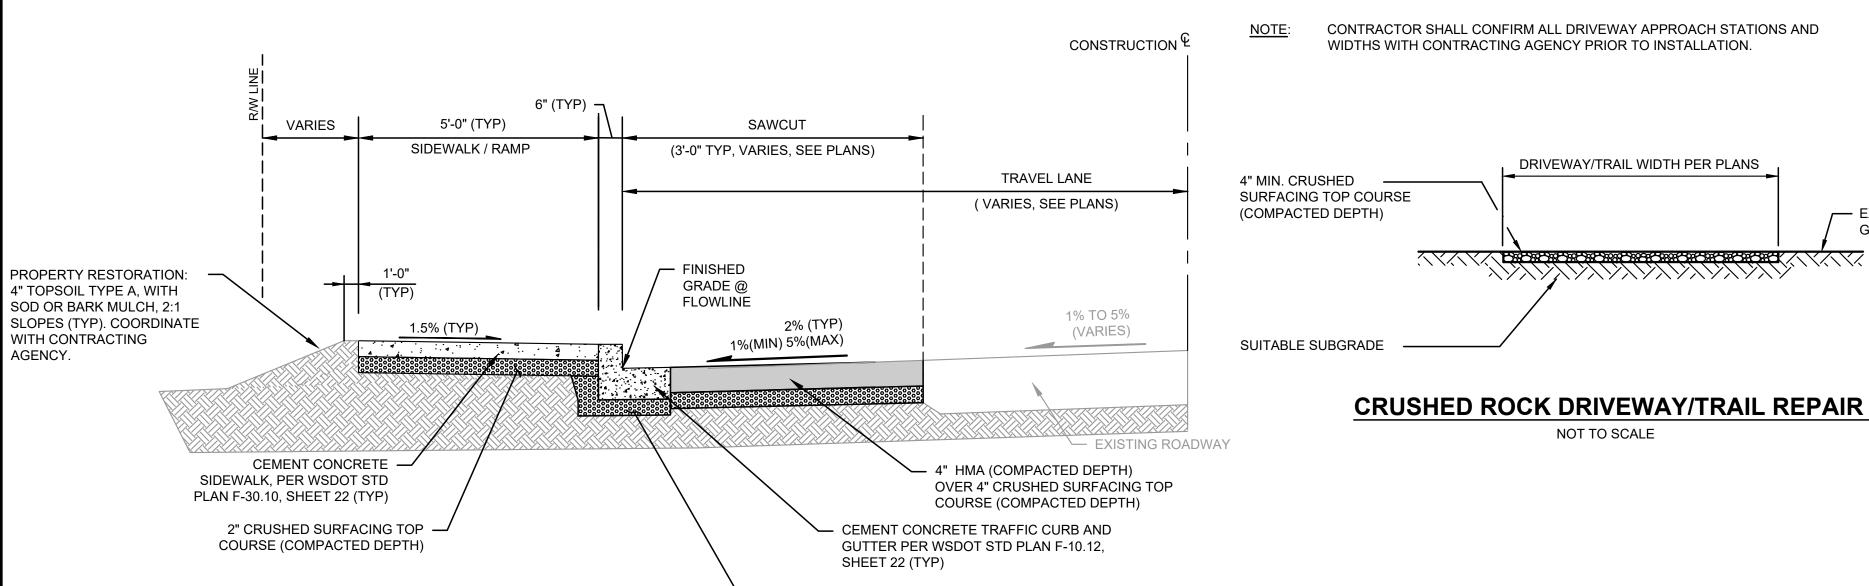


6" CRUSHED SURFACING TOP

TYPICAL CROSS-SECTION

NOT TO SCALE


COURSE (COMPACTED DEPTH)

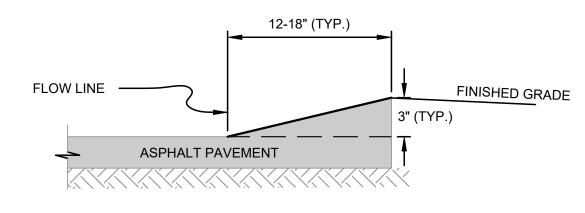

MATCH EXISTING WEDGE CURB DIMENSIONS.


HMA WEDGE CURB DETAIL

NOT TO SCALE

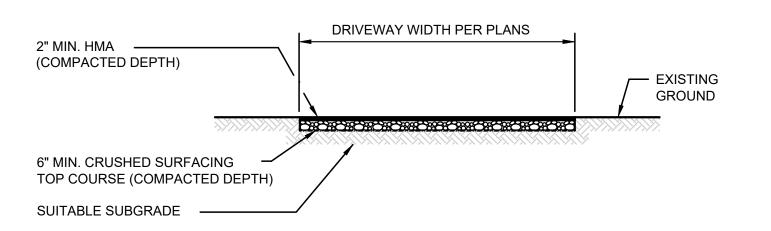

HMA DRIVEWAY REPAIR


NOT TO SCALE

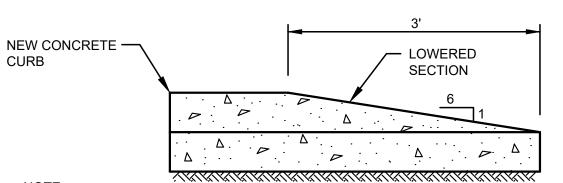

CONCRETE CURB END SECTION TO BE USED AT ALL LOCATIONS WHERE NEW CURB DOES NOT MEET EXISTING CURB, AT SIDEWALK TRANSITION SECTIONS AND/OR AS REQUIRED IN THE FIELD BY THE ENGINEER

CONCRETE CURB END SECTION

NOT TO SCALE

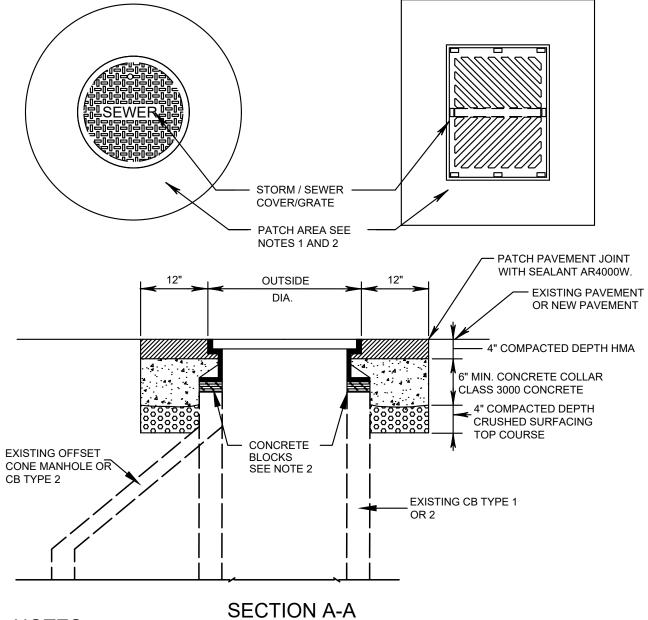

NOTES:


- EXISTING


GROUND

- 1. REMOVE PAVEMENT AND BASE MATERIALS FOR A DISTANCE WHICH IS EQUAL TO THE DIAMETER OF THE FRAME PLUS TWO FEET. ADJUST CASTING FRAME TO NEW PAVEMENT SURFACE USING CONCRETE BLOCKS & CONCRETE GROUT.
- 2. 2"x4"x8" SOLID BRICK USED FOR FINAL ADJUSTMENT TO GRADE. 6" HIGH MAX.

MANHOLE / CATCH BASIN - FRAME AND COVER ADJUSTMENT DETAIL NOT TO SCALE

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BID SET

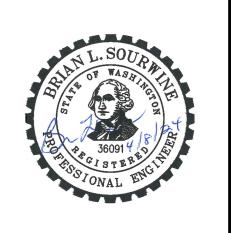
ISSUED FOR:

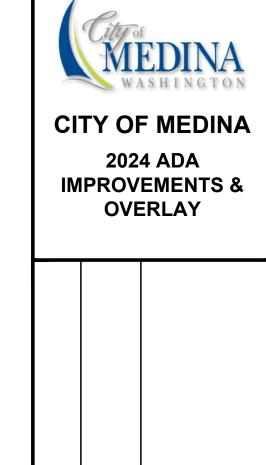No. DATE REVISION


ISSUE DATE: APR 2024 APPROVED BY: BLS CHECKED BY: BLS DRAWN BY: MAN DESIGNER: MAN G & O JOB NO.: 24432.00 RD-SD.DWG FILE:

ROADWAY DETAILS

SHEET: 21

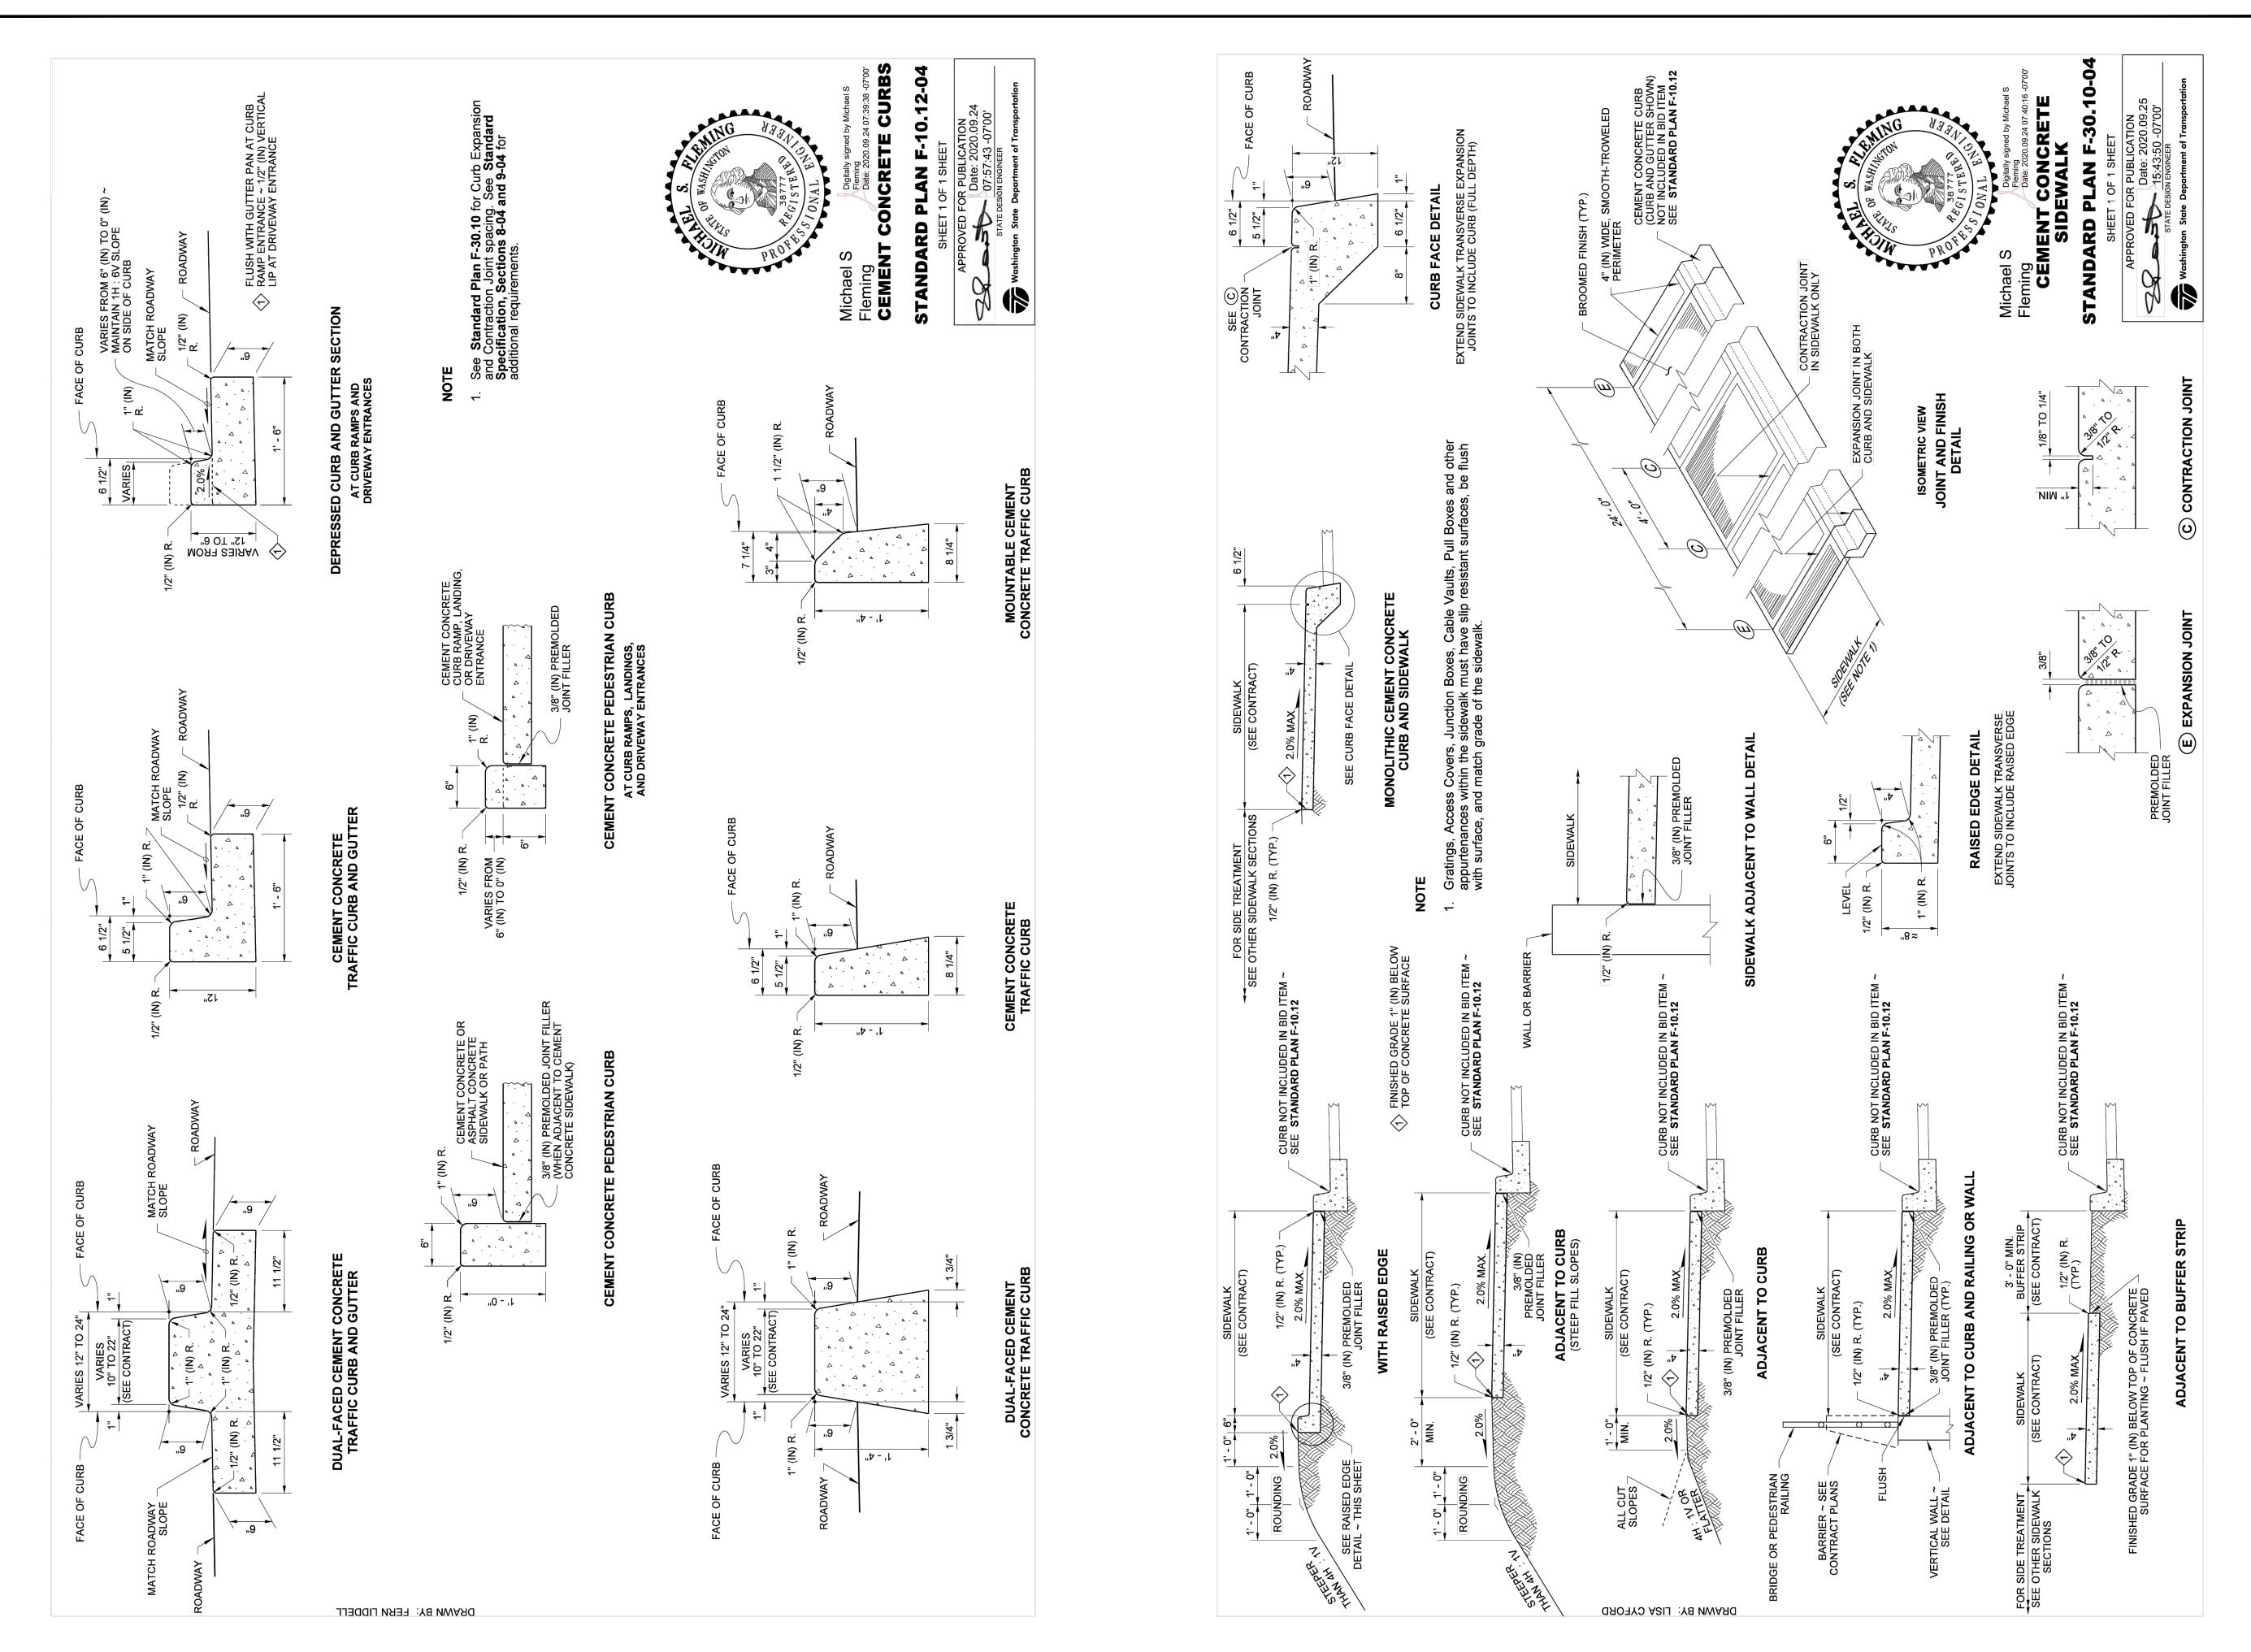

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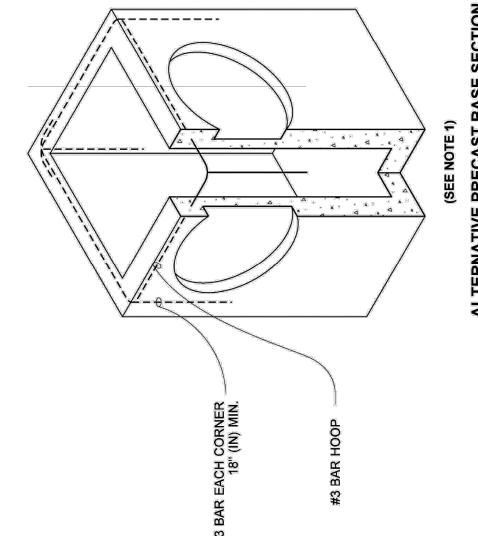
ROADWAY DETAILS

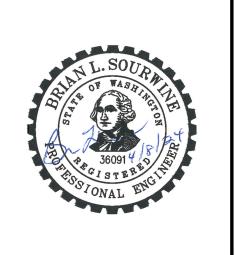SHEET: **22**


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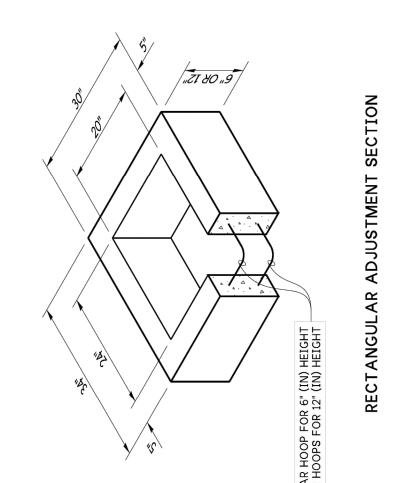
ALLOWANCES P | | |

PIPE MATERIAL	MAXIMUM INSIDE DIAMETER (INCHES)
REINFORCED OR PLAIN CONCRETE	12"
ALL METAL PIPE	15"
CPSSP ★ (STD, SPEC, SECT, 9-05.20)	12"
SOLID WALL PVC (STD. SPEC. SECT. 9-05.12(1))	15"
PROFILE WALL PVC (STD. SPEC. SECT. 9-05.12(2))	15"








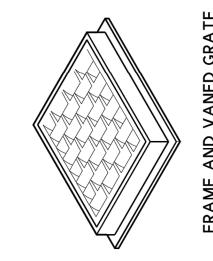

NCES	MAXIMUM INSIDE DIAMETER (INCHES)	12"	15"	12"	12"	15"	15"
PIPE ALLOWANCES	PIPE MATERIAL	REINFORCED OR PLAIN CONCRETE	ALL METAL PIPE	CPSSP ★ (STD. SPEC. SECT. 9-05.20)	POLYPROPYLENE (STD. SPEC. SECT. 9-05.24)	SOLID WALL PVC (STD. SPEC. SECT. 9-05.12(1))	PROFILE WALL PVC

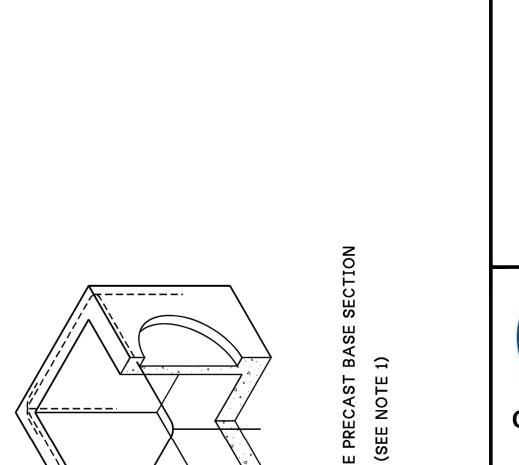



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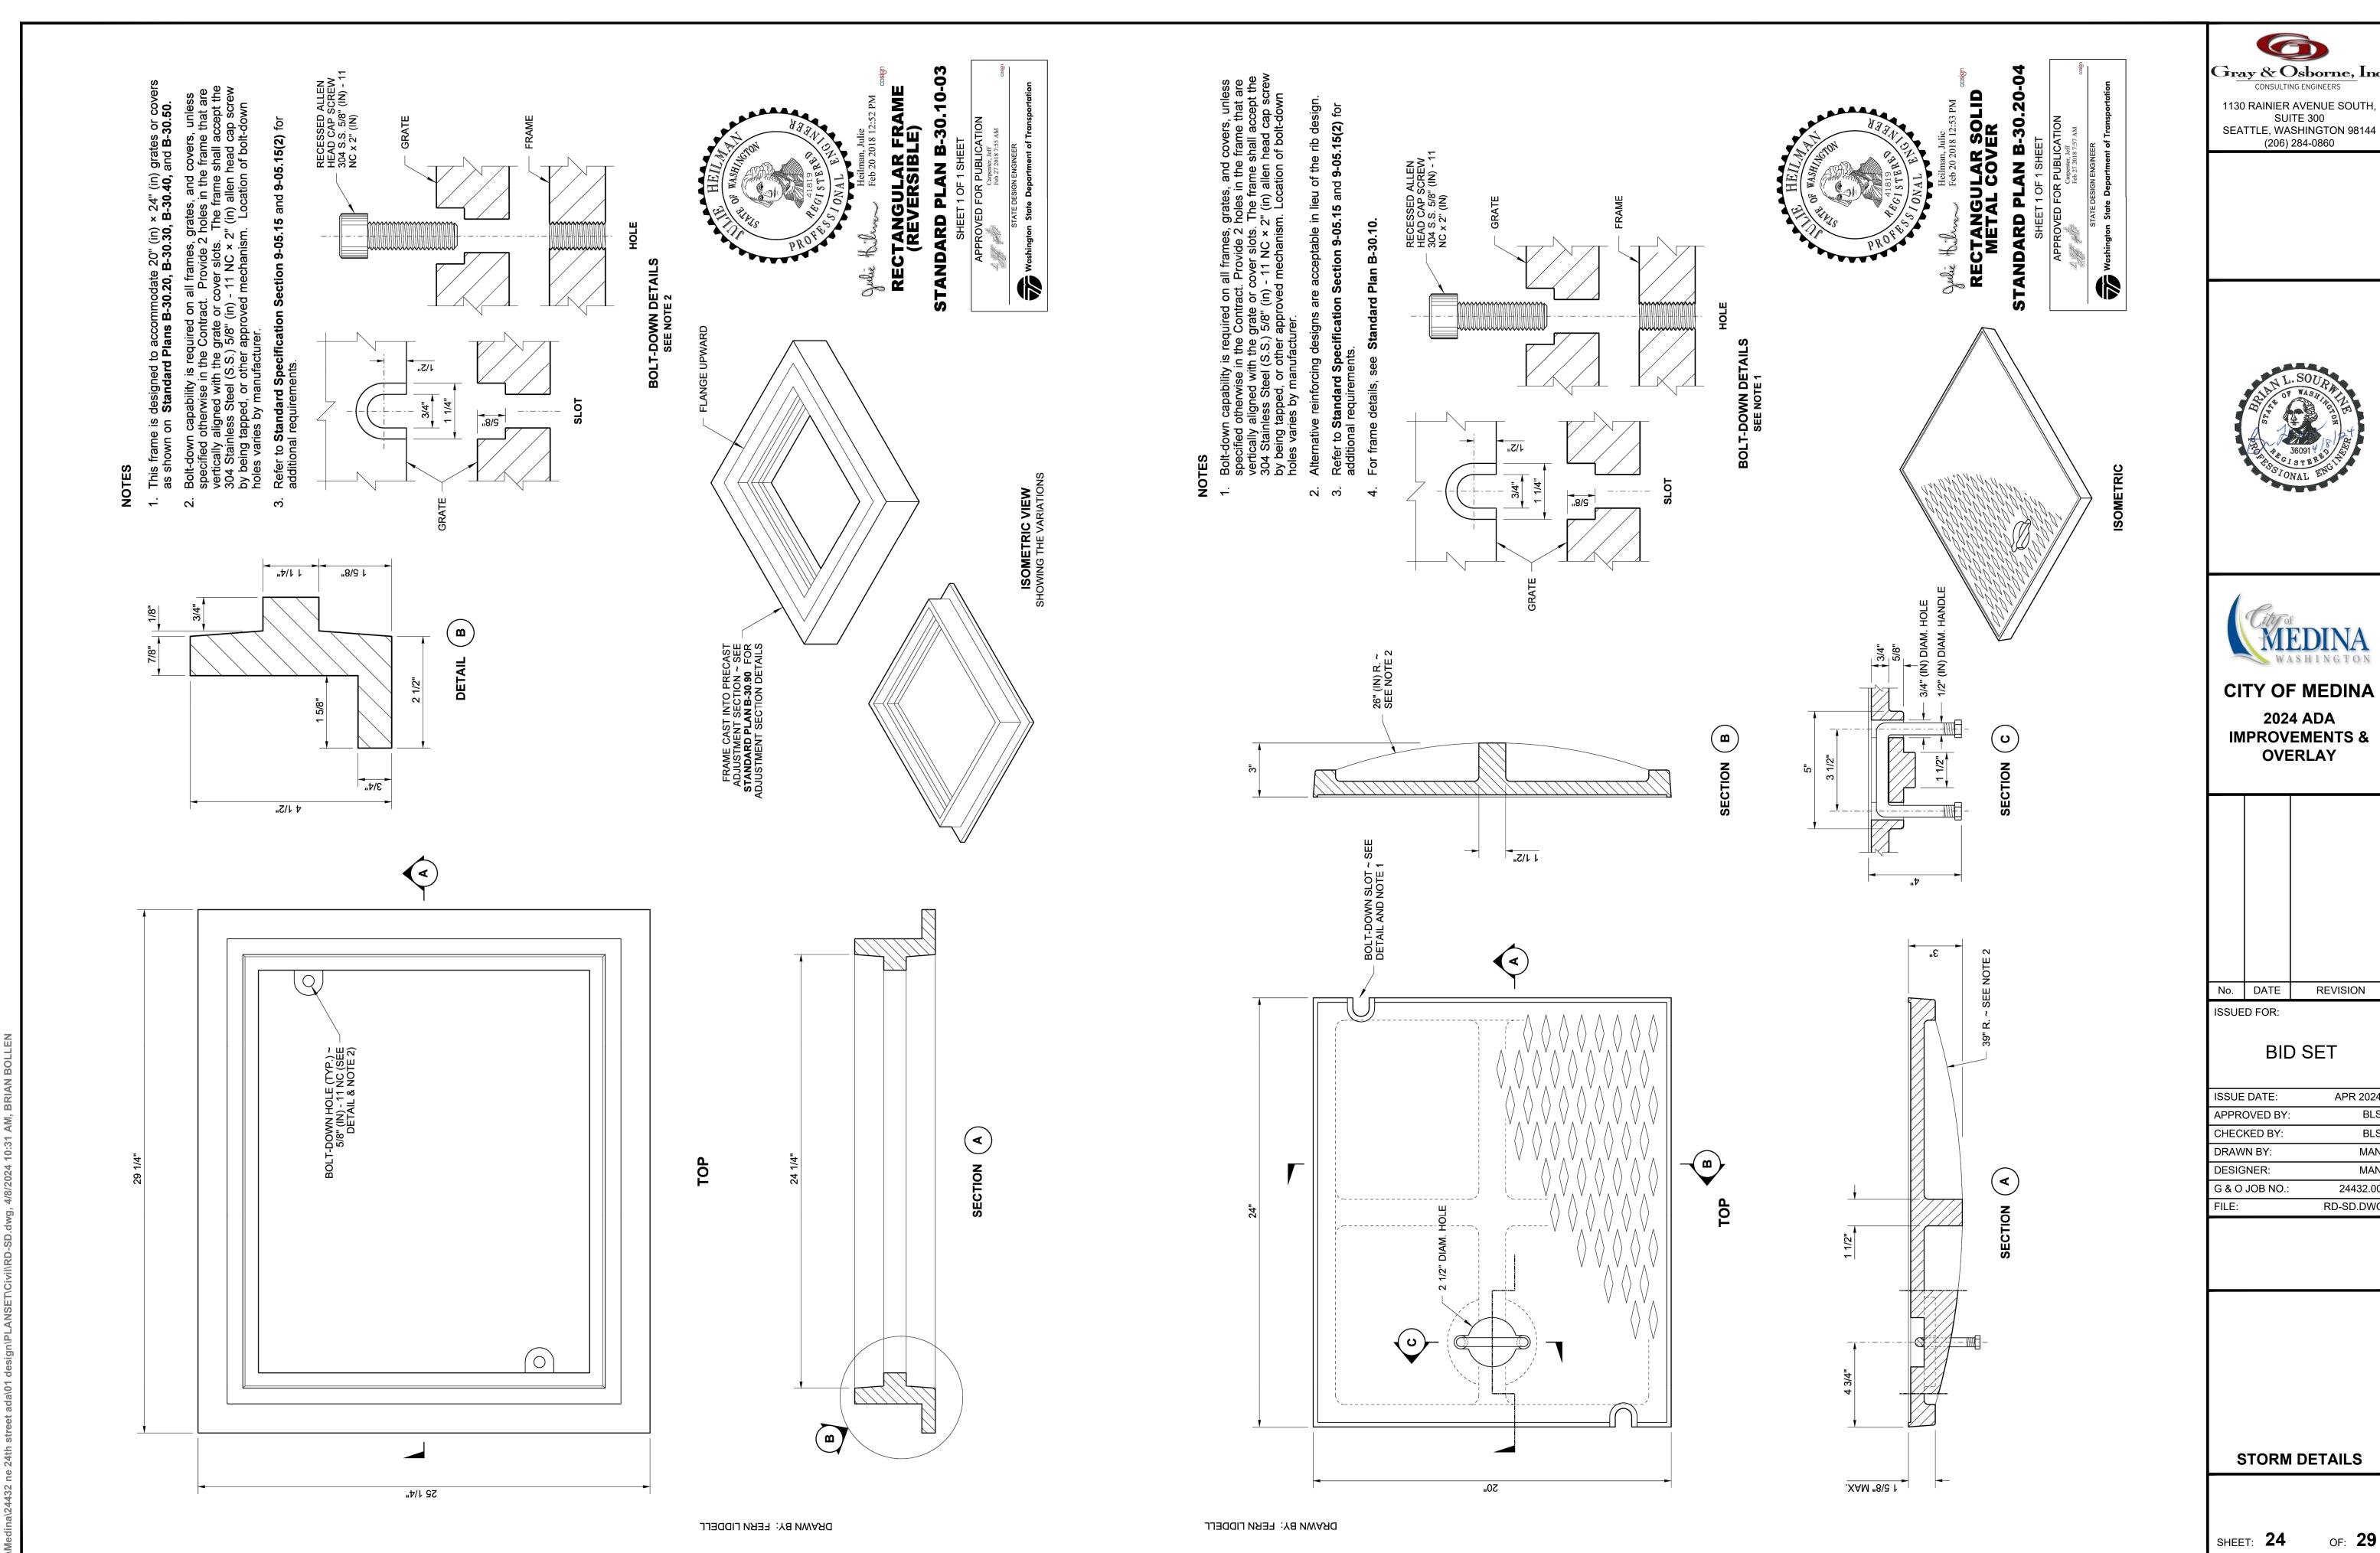


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SHEET: **23**


OF: **29**

STORM DETAILS



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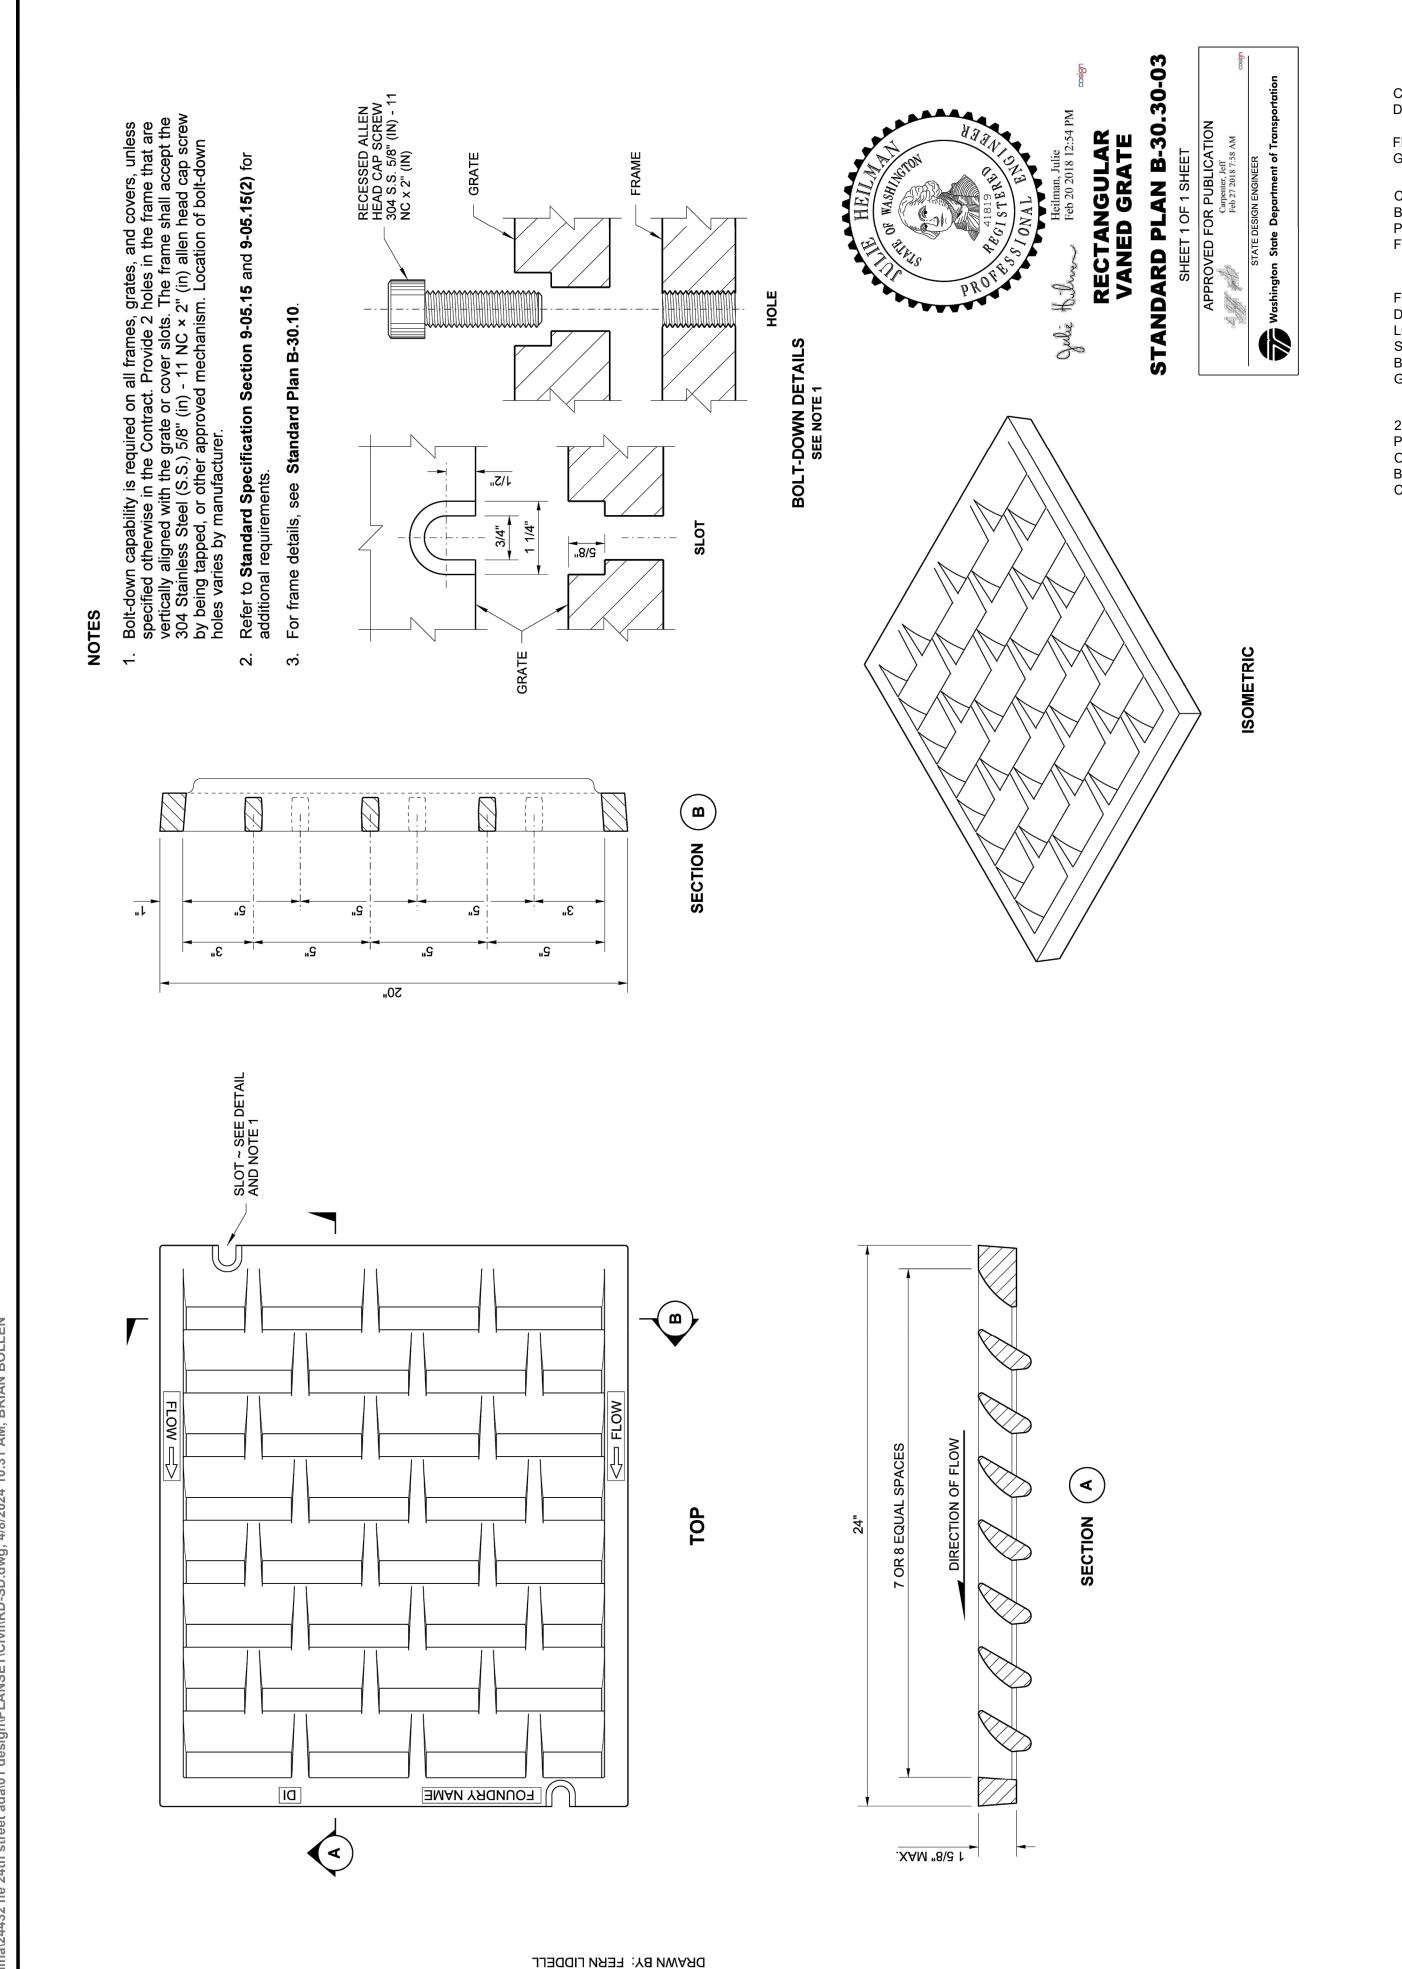



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APR 2024 APPROVED BY: BLS BLS MAN MAN G & O JOB NO.: 24432.00 RD-SD.DWG

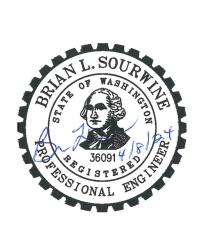STORM DETAILS


SHEET: **24**



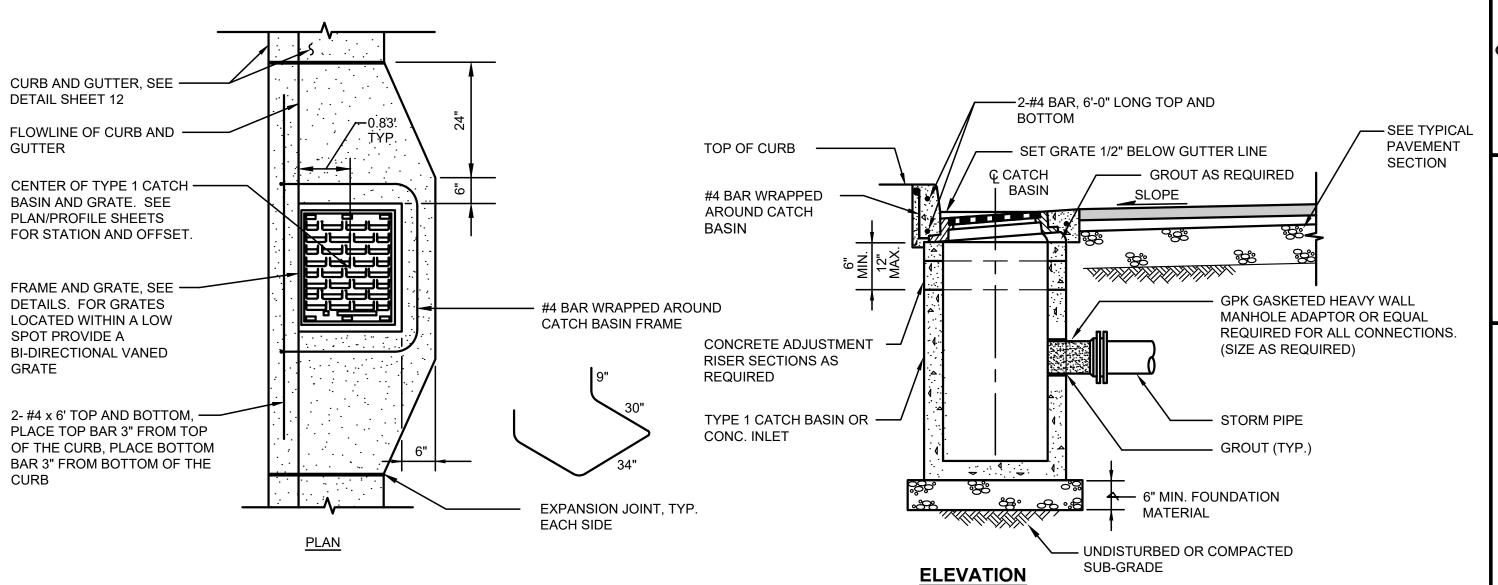

TYPE 1 CATCH BASIN INSTALLATION DETAIL W/ CURB AND GUTTER

NOT TO SCALE

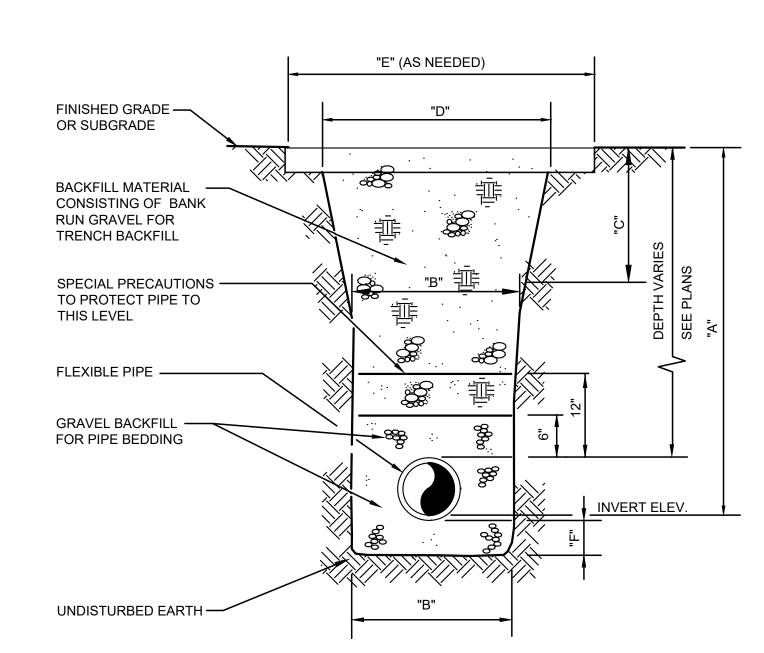

TRENCH SECTION - FLEXIBLE PIPE

NOT TO SCALE

NOTES:

- 1. THE TRENCH SECTIONS SHOWN ON THE PLANS ARE FOR THE PAYMENT LIMITS FOR BANK RUN GRAVEL FOR TRENCH BACKFILL. PAYMENT FOR ALL BANK RUN GRAVEL FOR TRENCH BACKFILL SHALL BE COMPUTED FROM THE MEASUREMENT OF THE CONSTRUCTED TRENCH SECTION, TO THE MAXIMUM LIMITS AS INDICATED IN THE TABLES.
- 2. WHERE A "NEW ROADWAY SECTION" OR PAVEMENT REPAIR IS PROPOSED, THE TRENCH SECTION PAYMENT LIMIT LINE WILL BE BOUNDED AT THE TOP BY PAVEMENT SUBGRADE, PER TYPICAL ROADWAY SECTION DETAILS.

12" DIAMETER PIPES

	6' OR											
Α	LESS	8'	10'	12'	14'	16'	18'	20'	22'	24'	26'	28'
В		3.00'										
С	1.50'	1.50'	1.75'	2.25'	2.75'	3.25'	3.75'	4.25'	4.75'	5.25'	5.75'	6.25'
D	6.00'	6.00'	6.50'	7.50'	8.50'	9.50'	10.50'	11.50'	12.50'	13.50'	14.50'	15.50'
E	7.00'	7.00'	7.50'	8.50'	9.50'	10.50'	11.50'	12.50'	13.50'	14.50'	15.50'	16.50'
F		4 in										

TYPICAL TRENCH EXCAVATION LIMITS STORM SEWER PIPE



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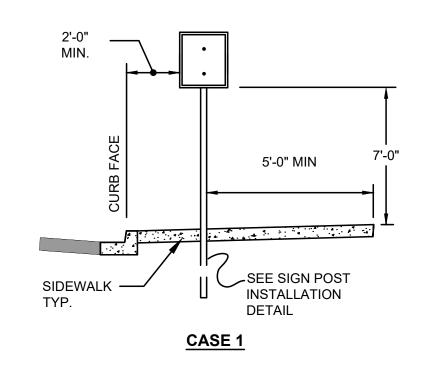
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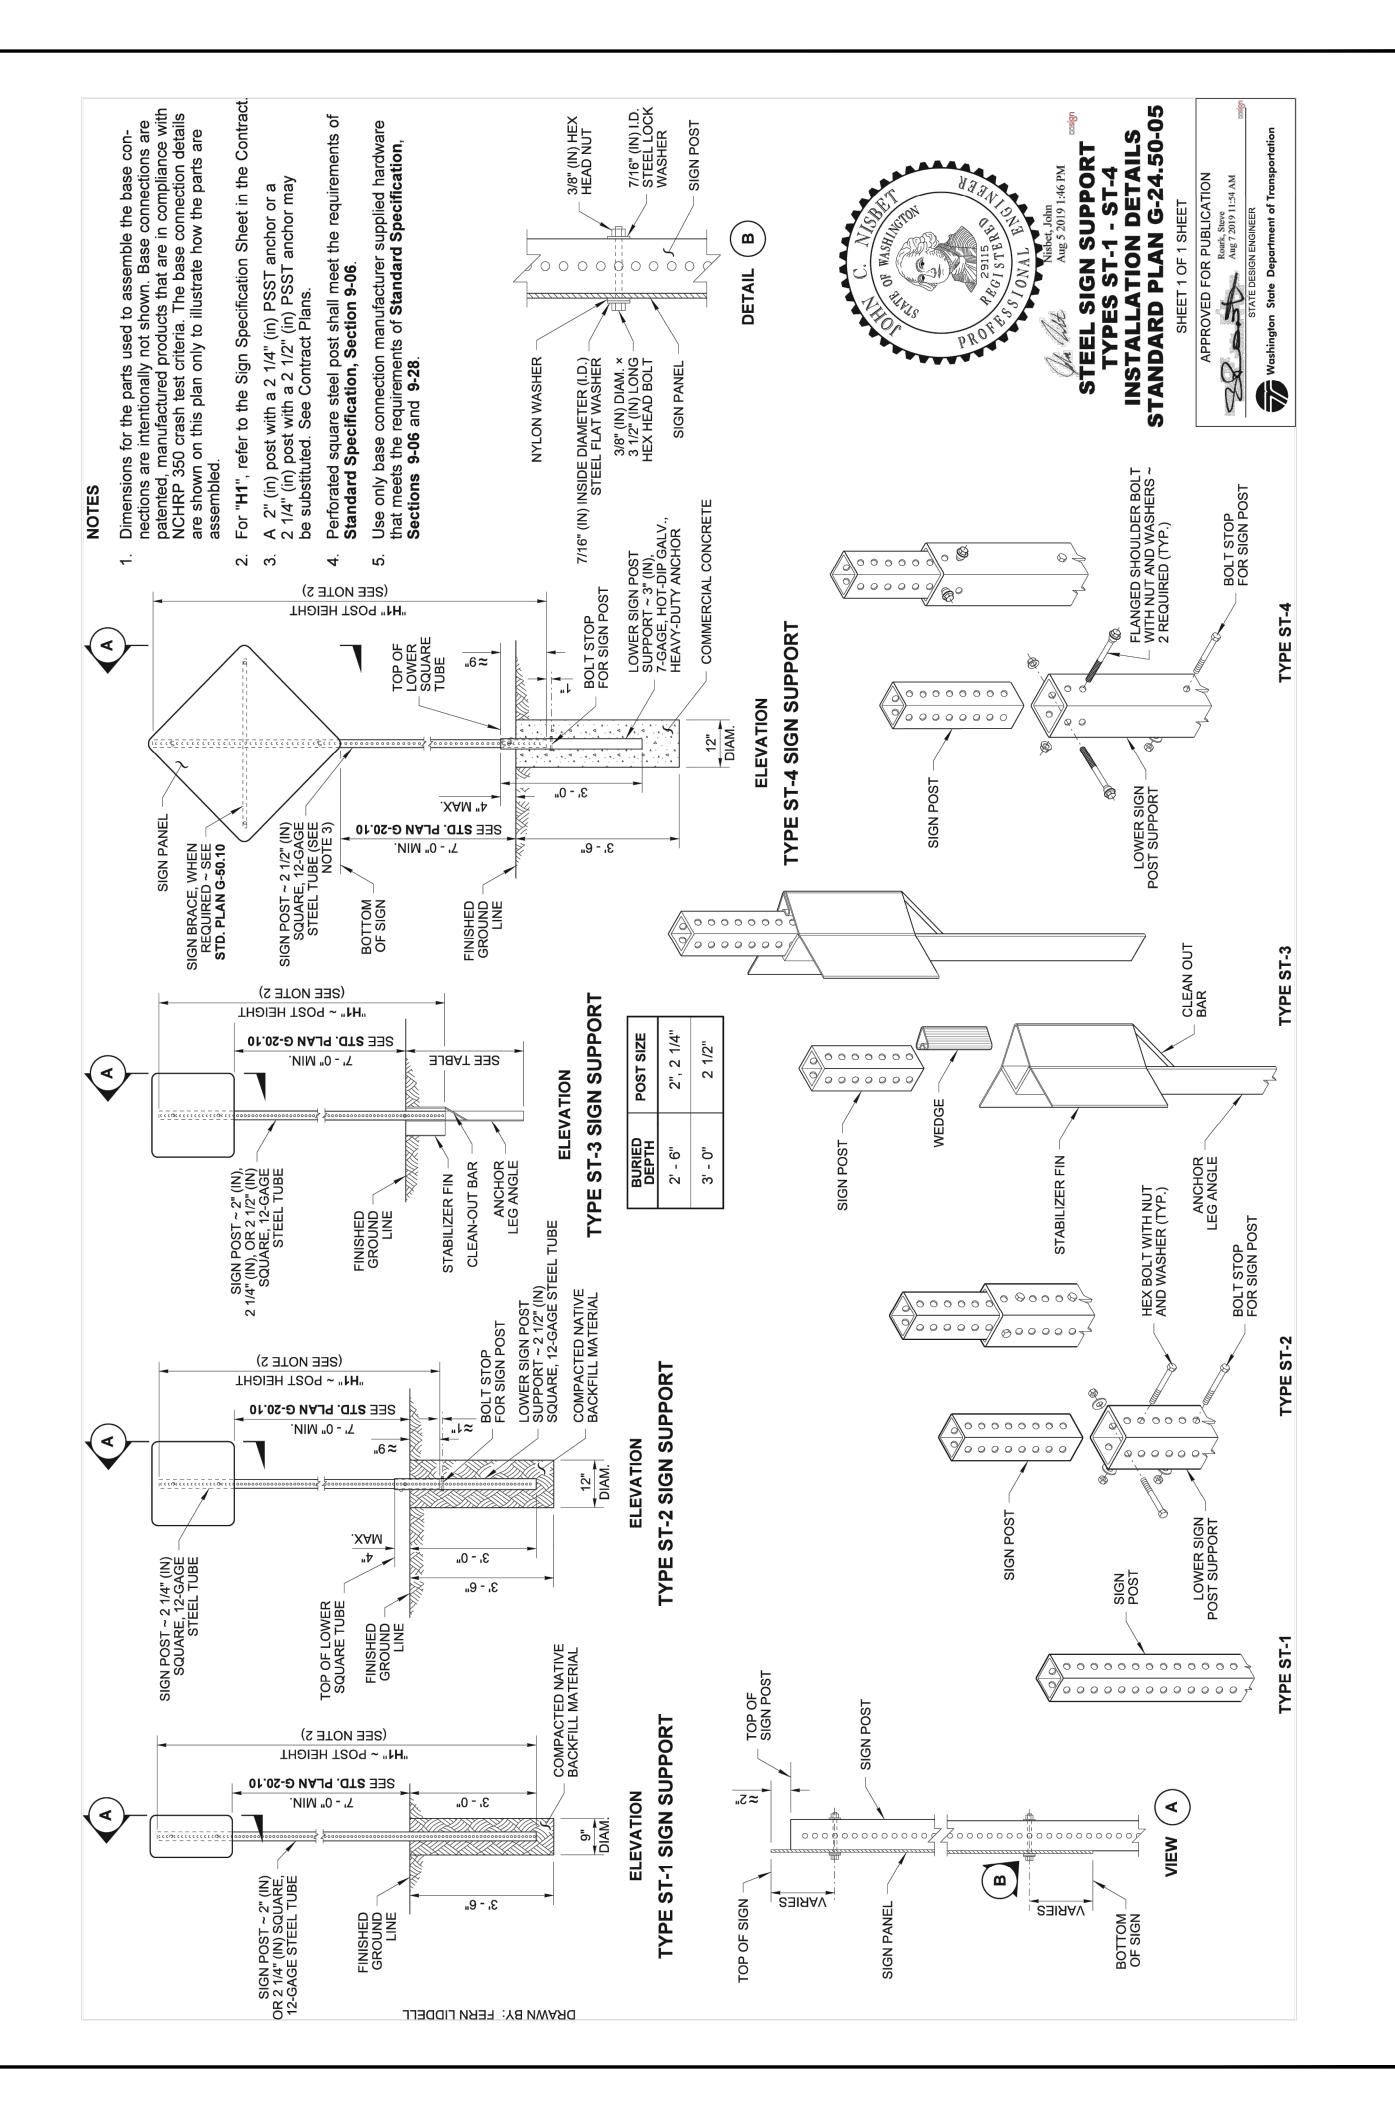
ISSUE DATE:	APR 2024
APPROVED BY:	BLS
CHECKED BY:	BLS
DRAWN BY:	MAN
DESIGNER:	MAN
G & O JOB NO.:	24432.00
FILE:	RD-SD.DWG

STORM DETAILS

SHEET: **25**



SIGN LOCATION DETAIL NOT TO SCALE





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No.	DATE	REVISION


ISSUED FOR:

BID SET

SSUE DATE:	APR 2024
APPROVED BY:	BLS
CHECKED BY:	BLS
DRAWN BY:	MAN
DESIGNER:	MAN
G & O JOB NO.:	24432.00
FILE:	CHAN-DET.DWG

CHANNELIZATION AND SIGNING DETAILS

OF: **29**

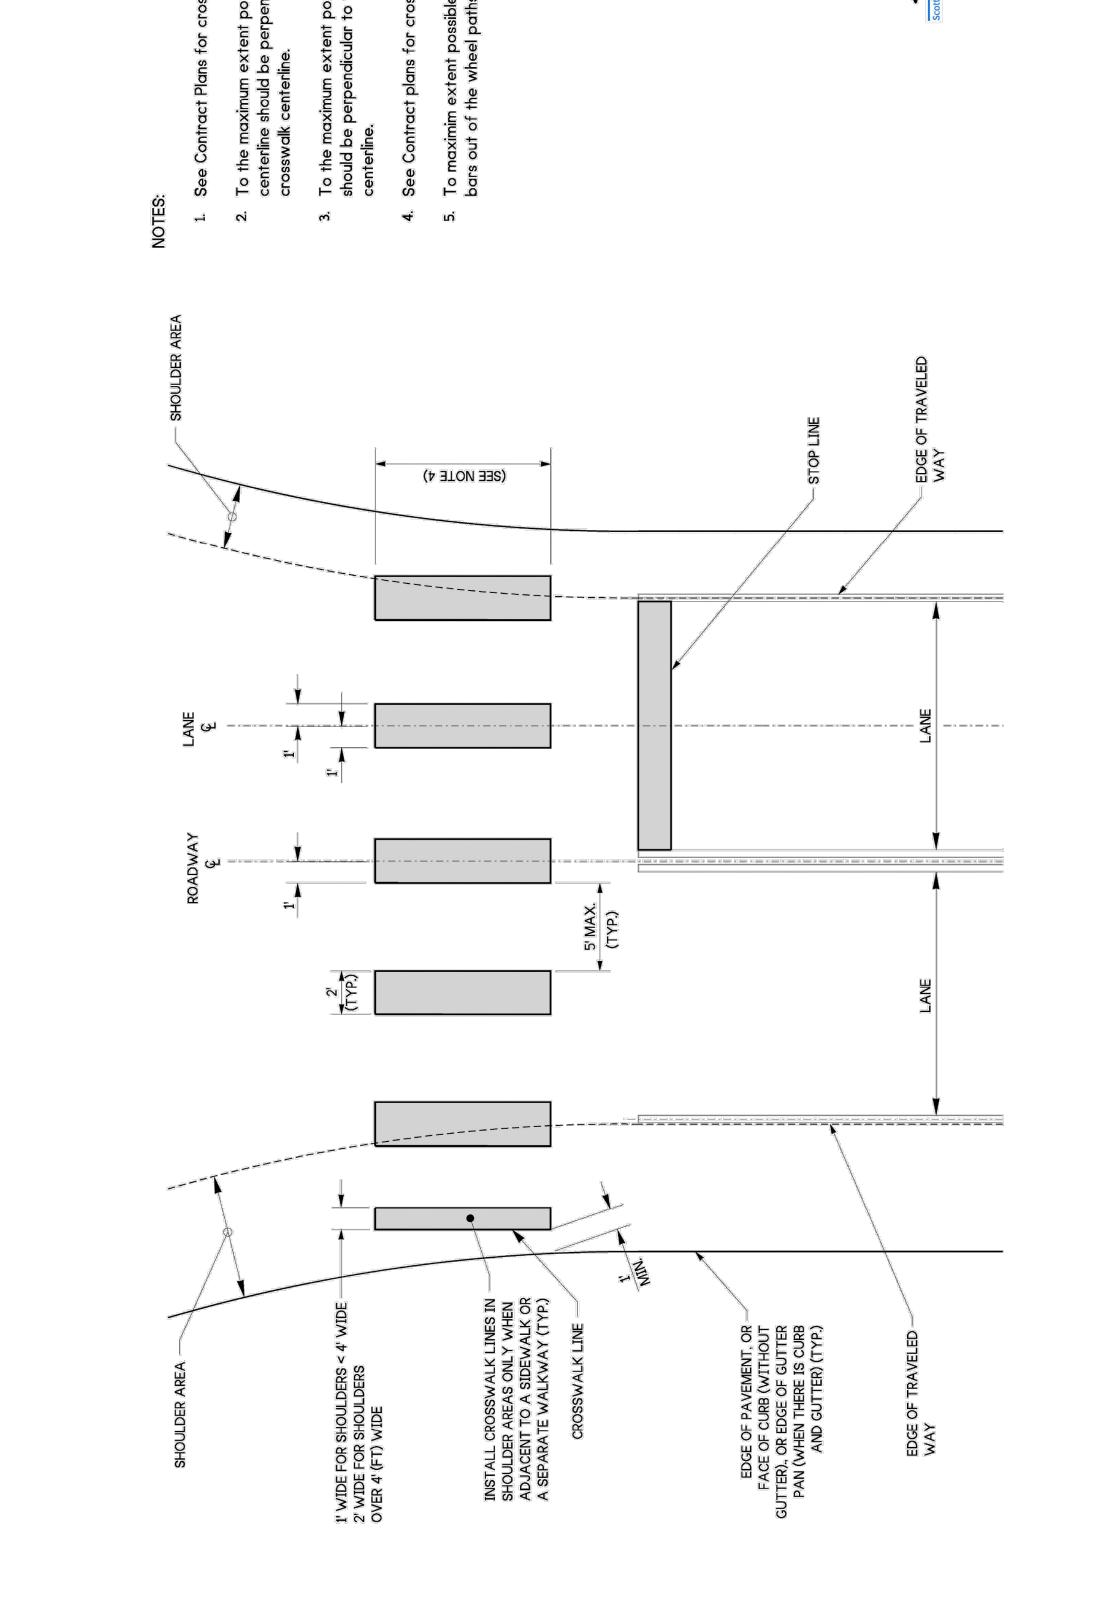

Gray & Osborne, Inc.
CONSULTING ENGINEERS

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CITY OF MEDINA

2024 ADA IMPROVEMENTS & OVERLAY

No. DATE REVISION ISSUED FOR:


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DESIGNER:	MAN
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FILE:	CHAN-DET.DWG
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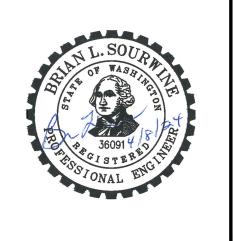
CHANNELIZATION AND SIGNING DETAILS


GENERAL TRAFFIC CONTROL NOTES

- 1. APPROPRIATE METHODS OF PEDESTRIAN AND VEHICULAR TRAFFIC CONTROL, INCLUDING FLAGGERS, SHALL BE EMPLOYED BY THE CONTRACTOR TO THE EXTENT DEEMED NECESSARY BY THE TRAFFIC CONTROL SUPERVISOR AND AS REQUIRED BY THE APPLICABLE AGENCY TO PROTECT WORKERS OR THIRD PARTIES.
- 2. THE CONTRACTOR AND/OR HIS AGENTS SHALL NOT PARK IN ANY PRIVATE PARKING LOTS / DRIVEWAYS WITHOUT WRITTEN PERMISSION FROM THE PROPERTY OWNER.
- 3. SEE ALSO SPECIFICATIONS AND SPECIAL PROVISIONS, INCLUDING WSDOT STANDARD SPECIFICATION SECTION 1-07.23(1).
- 4. ALL WARNING SIGNS SHALL BE 48" X 48". FOR OTHER SIGN SIZES REFER TO MANUAL ON UNIFORM TRAFFIC CONTROL DEVICES (MUTCD) AND WSDOT SIGN FABRICATION MANUAL M55-05.





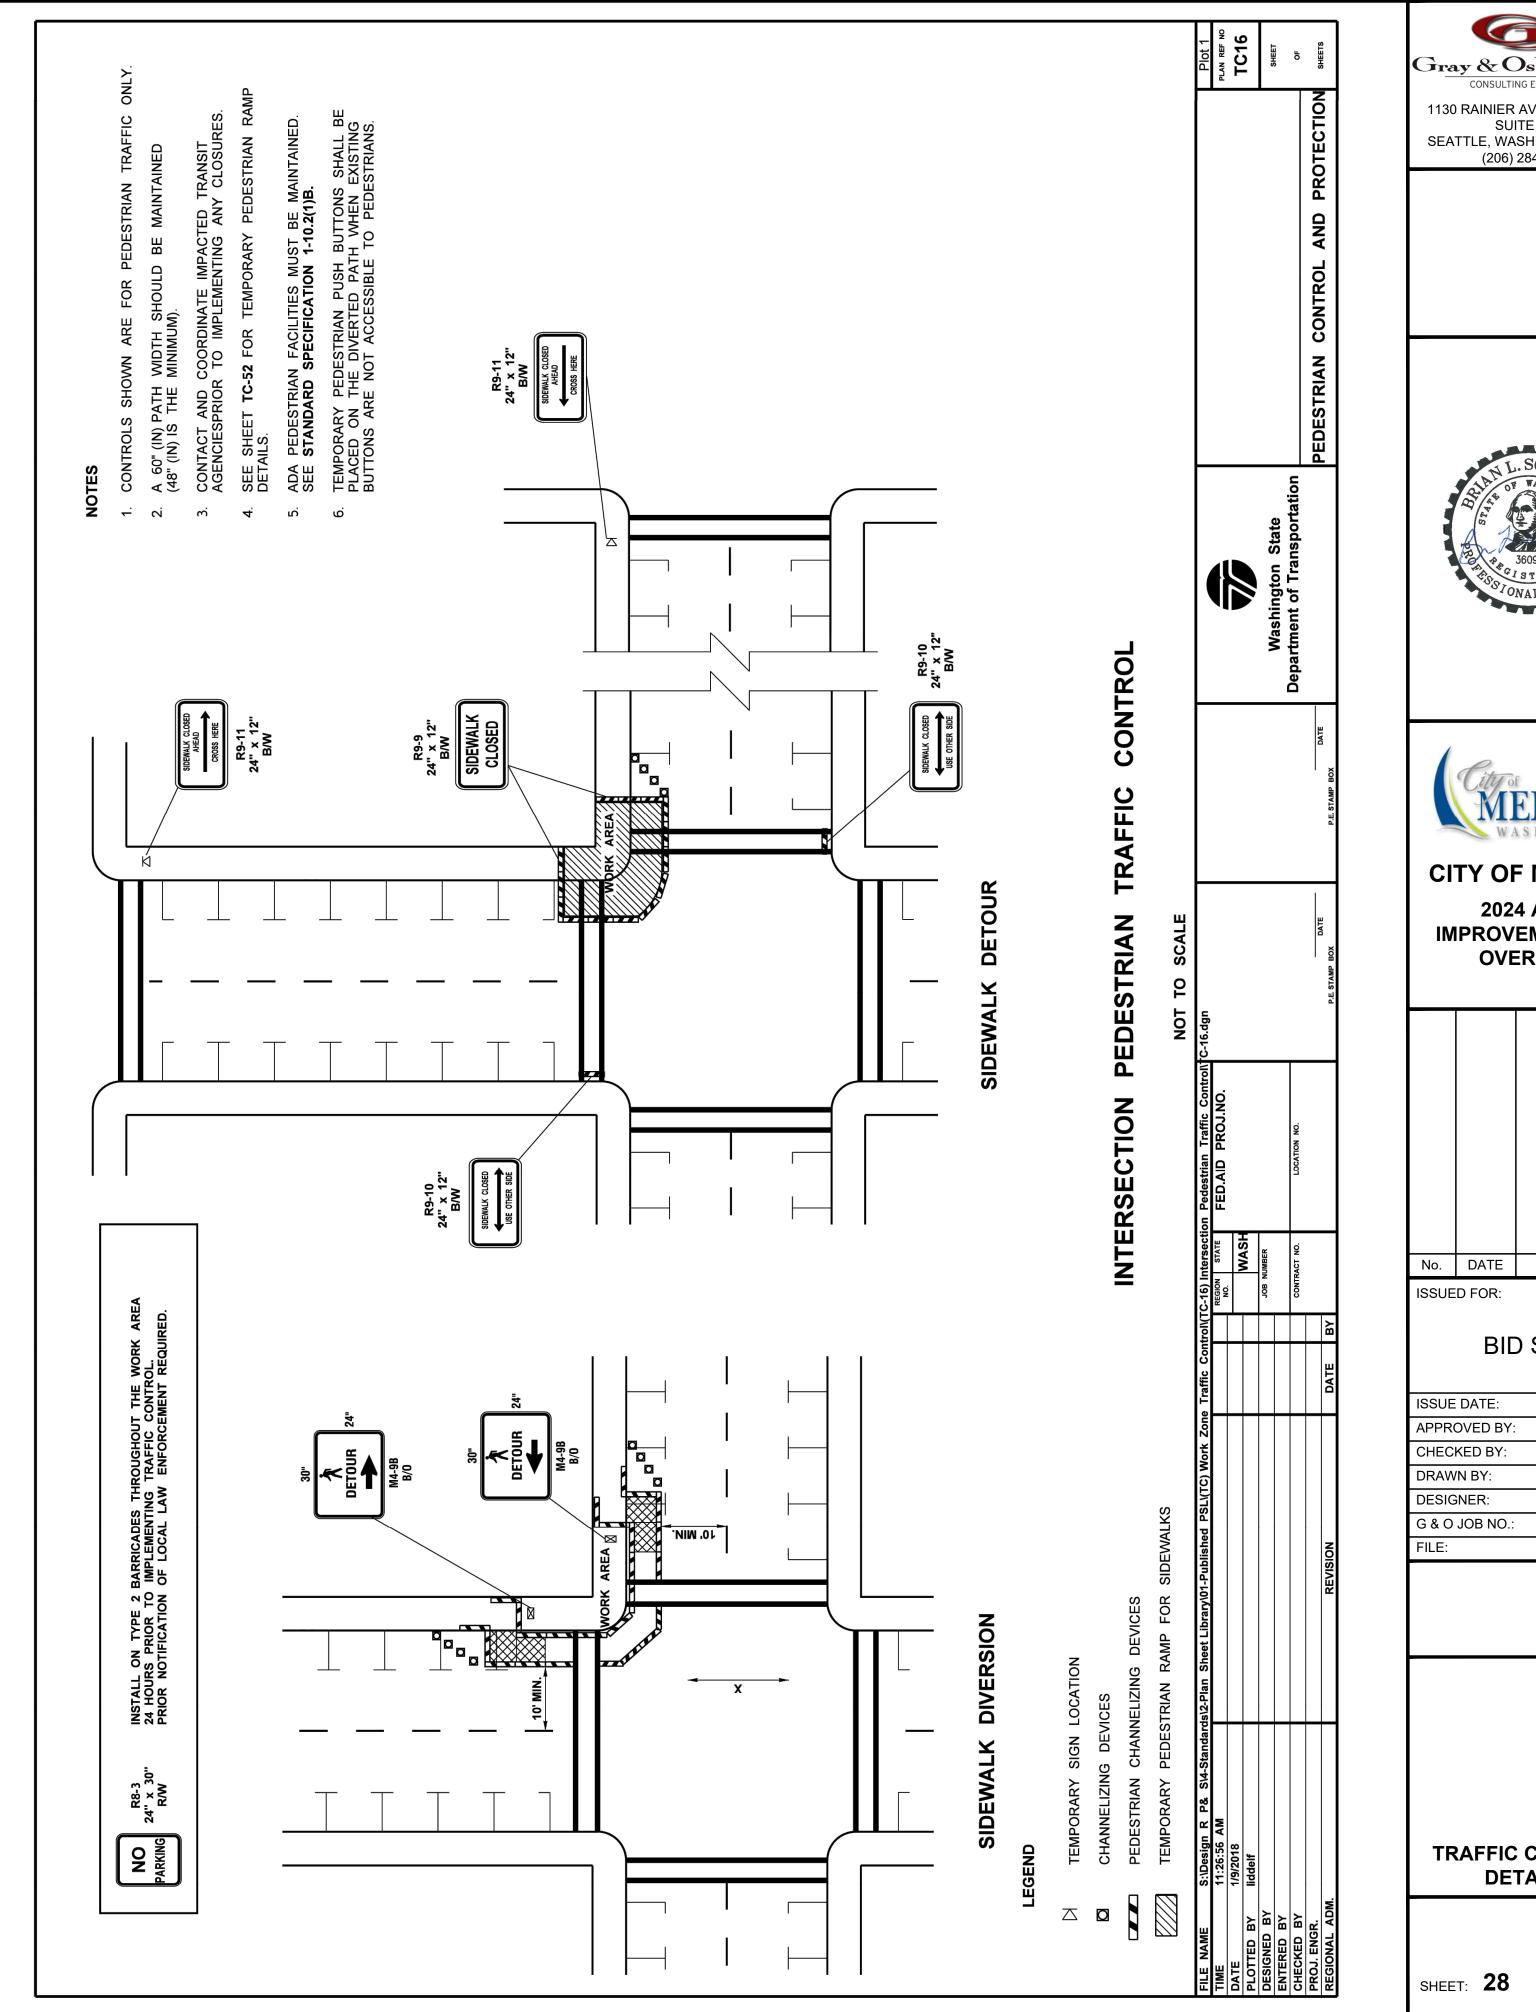


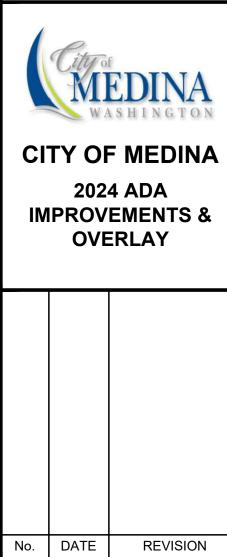

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APPROVED BY:	BLS
CHECKED BY:	BLS
DRAWN BY:	MAN
DESIGNER:	MAN
G & O JOB NO.:	24432.00
FILE:	TC-DET.DWG

TRAFFIC CONTROL DETAILS

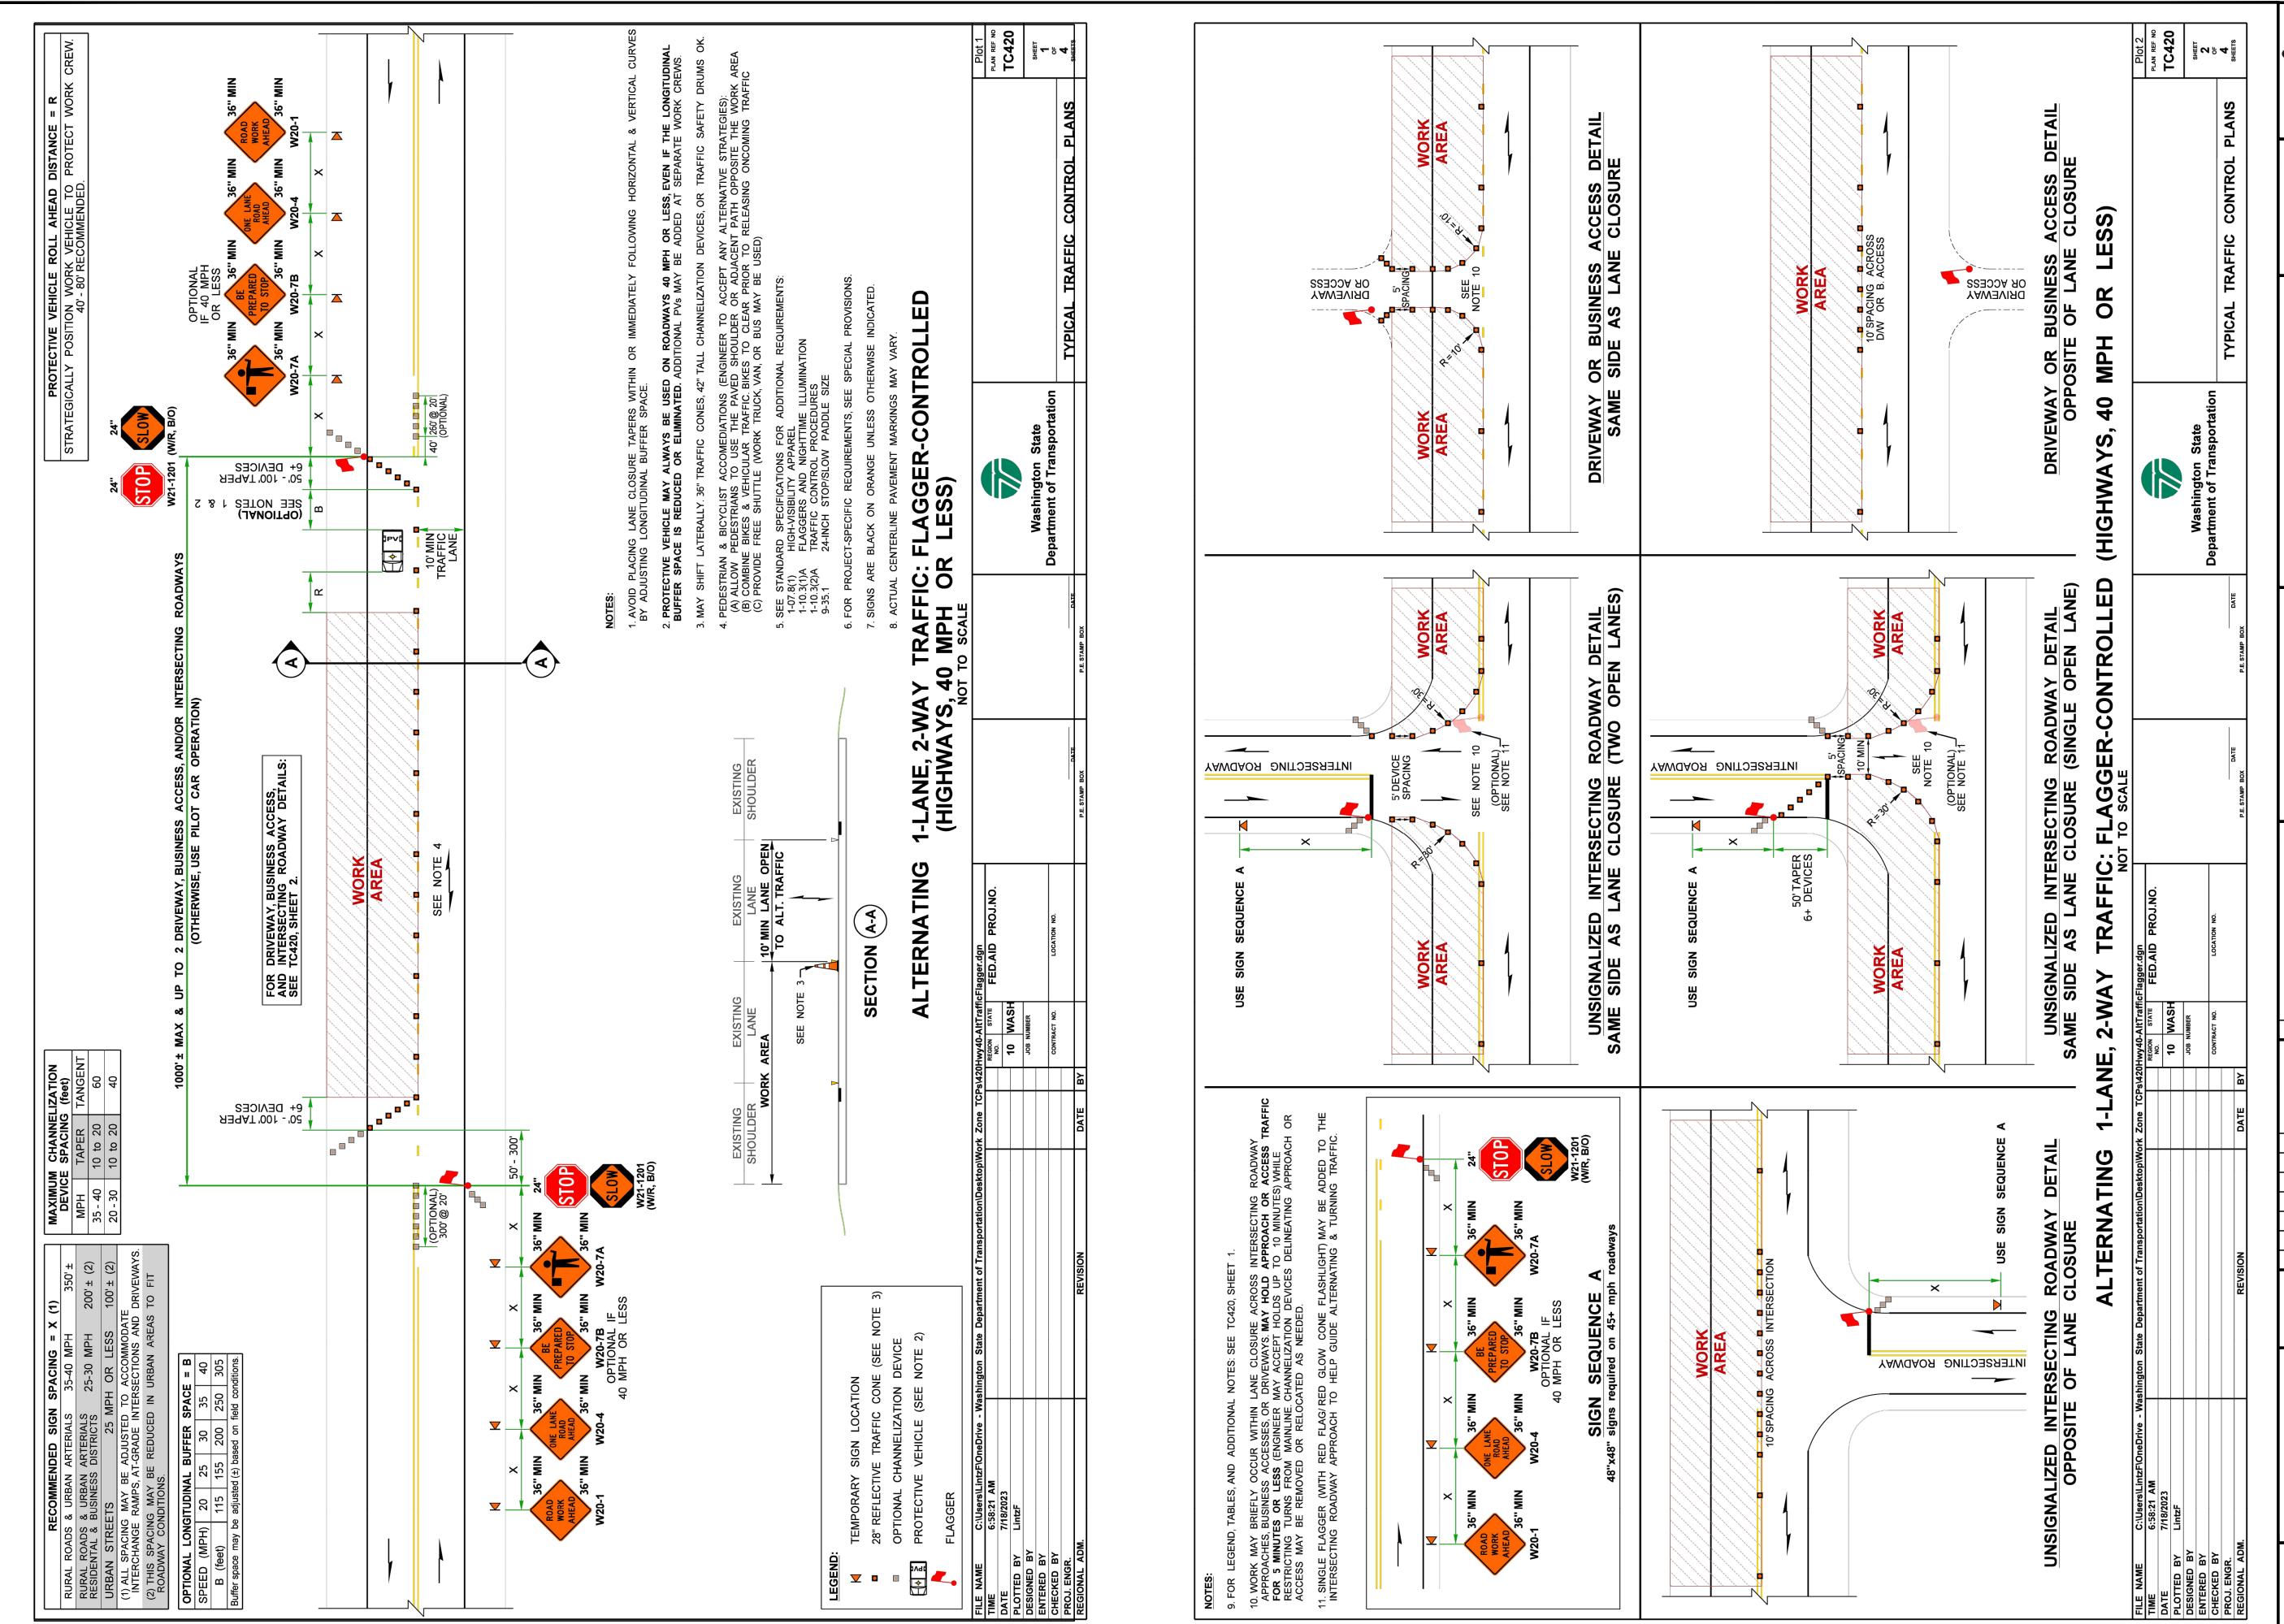

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CITY OF MEDINA

2024 ADA

IMPROVEMENTS &

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TRAFFIC CONTROL **DETAILS**

SHEET: **29**